

PANANIA - LAHC 2021/505

171 Weston St & 2-6 Hinemoa St, Panania, NSW, 2213

LOT 42, 43, 44, 45 / DP35211

| UNITS TYPES | |
|----------------------|-------|
| Type | Count |
| 1BR | 16 |
| 1BR Gold | 6 |
| 2BR | 15 |
| 2BR Adaptable | 1 |
| 2BR Adaptable + Gold | 4 |
| TOTAL APARTMENTS: 42 | 42 |

SILVER/GOLD LIVEABLE UNITS - CONSTRUCTION NOTES



- Hobless Shower
Walls need to be such that flush transition is available.

Silver Units: 1, 3, 5, 9, 10, 11, 12, 13, 15, 16, 17, 19, 20, 21, 22, 23, 25, 26, 27, 29, 30, 31, 32, 33, 35, 36, 37, 39, 40, 41, 42.
Gold Units: 4, 6, 7, 8, 14, 18, 24, 28, 34, 38.

| GROSS FLOOR AREA | |
|------------------|-----------------------|
| Level | Area |
| GROUND LEVEL B | 761.6 m ² |
| LEVEL 1A | 774.3 m ² |
| LEVEL 2A | 774.3 m ² |
| LEVEL 3A | 774.3 m ² |
| LEVEL 4A | 310.9 m ² |
| | 3395.3 m ² |





| CAR SPACES - TYPES | |
|---|--------|
| Type | Number |
| Class 1a - 2400w x 5400d (Resident/Employee) | 14 |
| Class 4 - 2400w x 5400d (Disabled) | 5 |
| | 19 |

| DESIGN COMPLIANCE TABLE | | | |
|--|---------------------------|--|---|
| SITE AREA | 2264.749m ² | | |
| | CONTROL | REQUIRED OR ALLOWED | PROPOSED |
| FSR | LEP | 1:1 | 1.50:1 |
| | HSEPP 2021 | 1:1 (LEP) + 0.5 bonus (HSEPP) = 1.5:1 | |
| HEIGHT | CBLEP 2023 HSEPP 2021 | 13m + 30% bonus (proposed under Housing SEPP 2021) = 16.9m | Less than 16.9m Parapet = 17.5m |
| UNITS MIX | LAHC | 22 x 1bed + 20 x 2bed (42 units) | 22 x 1bed 20 x 2bed (42 units) |
| SETBACK | DCP | FRONT -Primary street frontage: 6m -Secondary street frontage: 6m | Weston St GL: 6.0m / 2.9m (terraces) L1-3: 6.0m / 5.5m (balconies) Hinemoa St GL: 6.0m / 1.5m (terraces) L1-3: 6.0m / 5.5m (balconies) |
| | | SIDE REAR -3 or more storeys: 4.5m -Average setback: 0.6 multiplied by the wall height: $12.88 \times 0.6 = 7.728m$ -Basement: 2m -Driveway: 1m | GL: 6.0m / 4.8m (terrace) L1-3: 6.0m / 6.0m (balcony) GL: 8.1m / 1.8m (terrace) L1-3: 6.0m / 6.0m (balcony) |
| CAR PARKING | Housing SEPP 2021 | 0.4 spaces per 1 bed dwellings 0.5 spaces per 2 bed dwellings | 8.8+10=19 car spaces required (including 5 accessible car spaces) |
| LANDSCAPING | H. SEPP 2021 | the lesser 35m ² per dwelling (1470m ²) 30% of the site (679.44m ²) | 816.1m ² / 36.0% Comply 314.4m ² / 38.5% of total (forward of the building line) |
| DEEP SOIL | ADG | -Min 15% of site area with min 3m dimension (339.75m ²) -Min 7% of site area with min 6m dimension (158.55m ²) | 225.1+431.3 = 656.4m ² 28.9% - Comply 431.3m ² = 19.0% - Comply |
| PRIVATE OPEN SPACE | Housing SEPP 2021 and ADG | GROUND - 15m² / 3metre dim. UPPER FLOORS - 8m² / 2m - 1bed UPPER FLOORS - 10m² / 2m - 2beds | Comply |
| SOLAR ACCESS | Housing SEPP 2021 and ADG | -70% of units for 2 hours between 9am-3pm mid-winter to living areas and POS | 78.6% Comply |
| COMMUNAL OPEN SPACE | ADG | Communal open space has a minimum area equal to 25% of the site (566m ²) | 566 / 25% Comply |
| LIVEABLE AND ADAPTABLE HOUSING APPROACH. | DCP | 20% Silver Standard 20% Gold Standard | 32/42 -76.2% Silver Standard 10/42 -23.8% Gold Standard 5/42 -11.9% -Adaptable Note: Some units are both Adaptable and Silver/Gold |

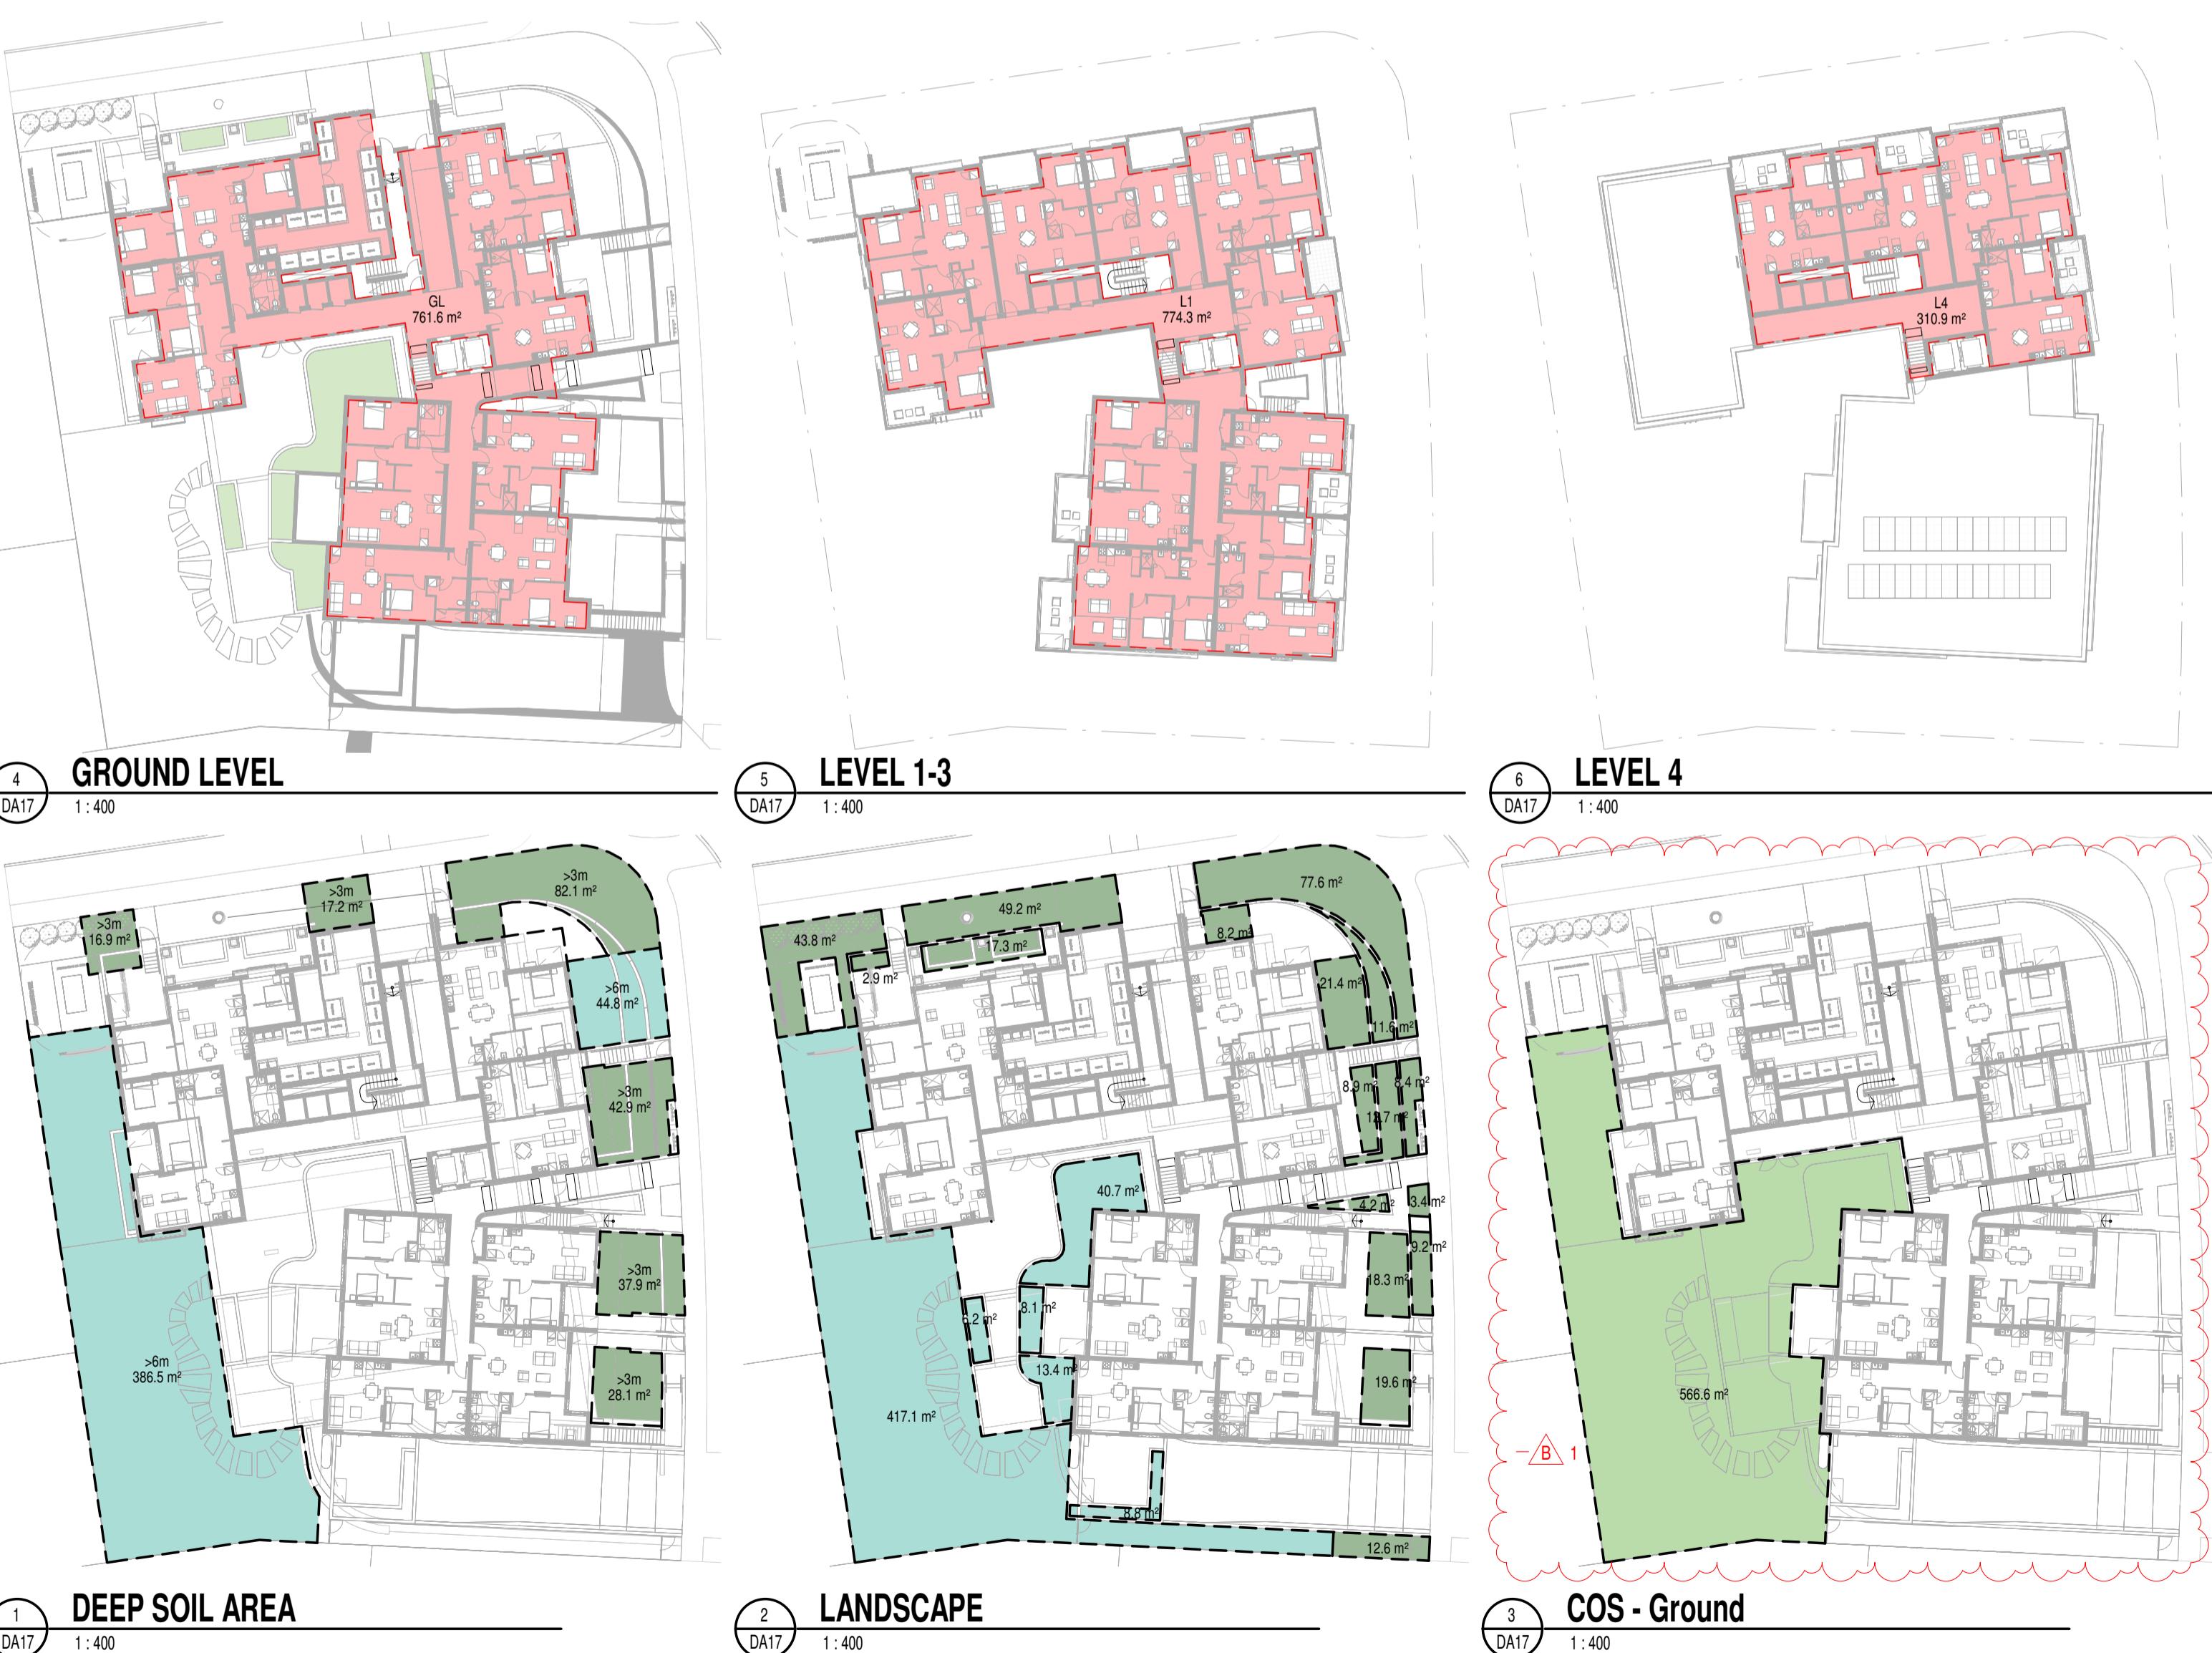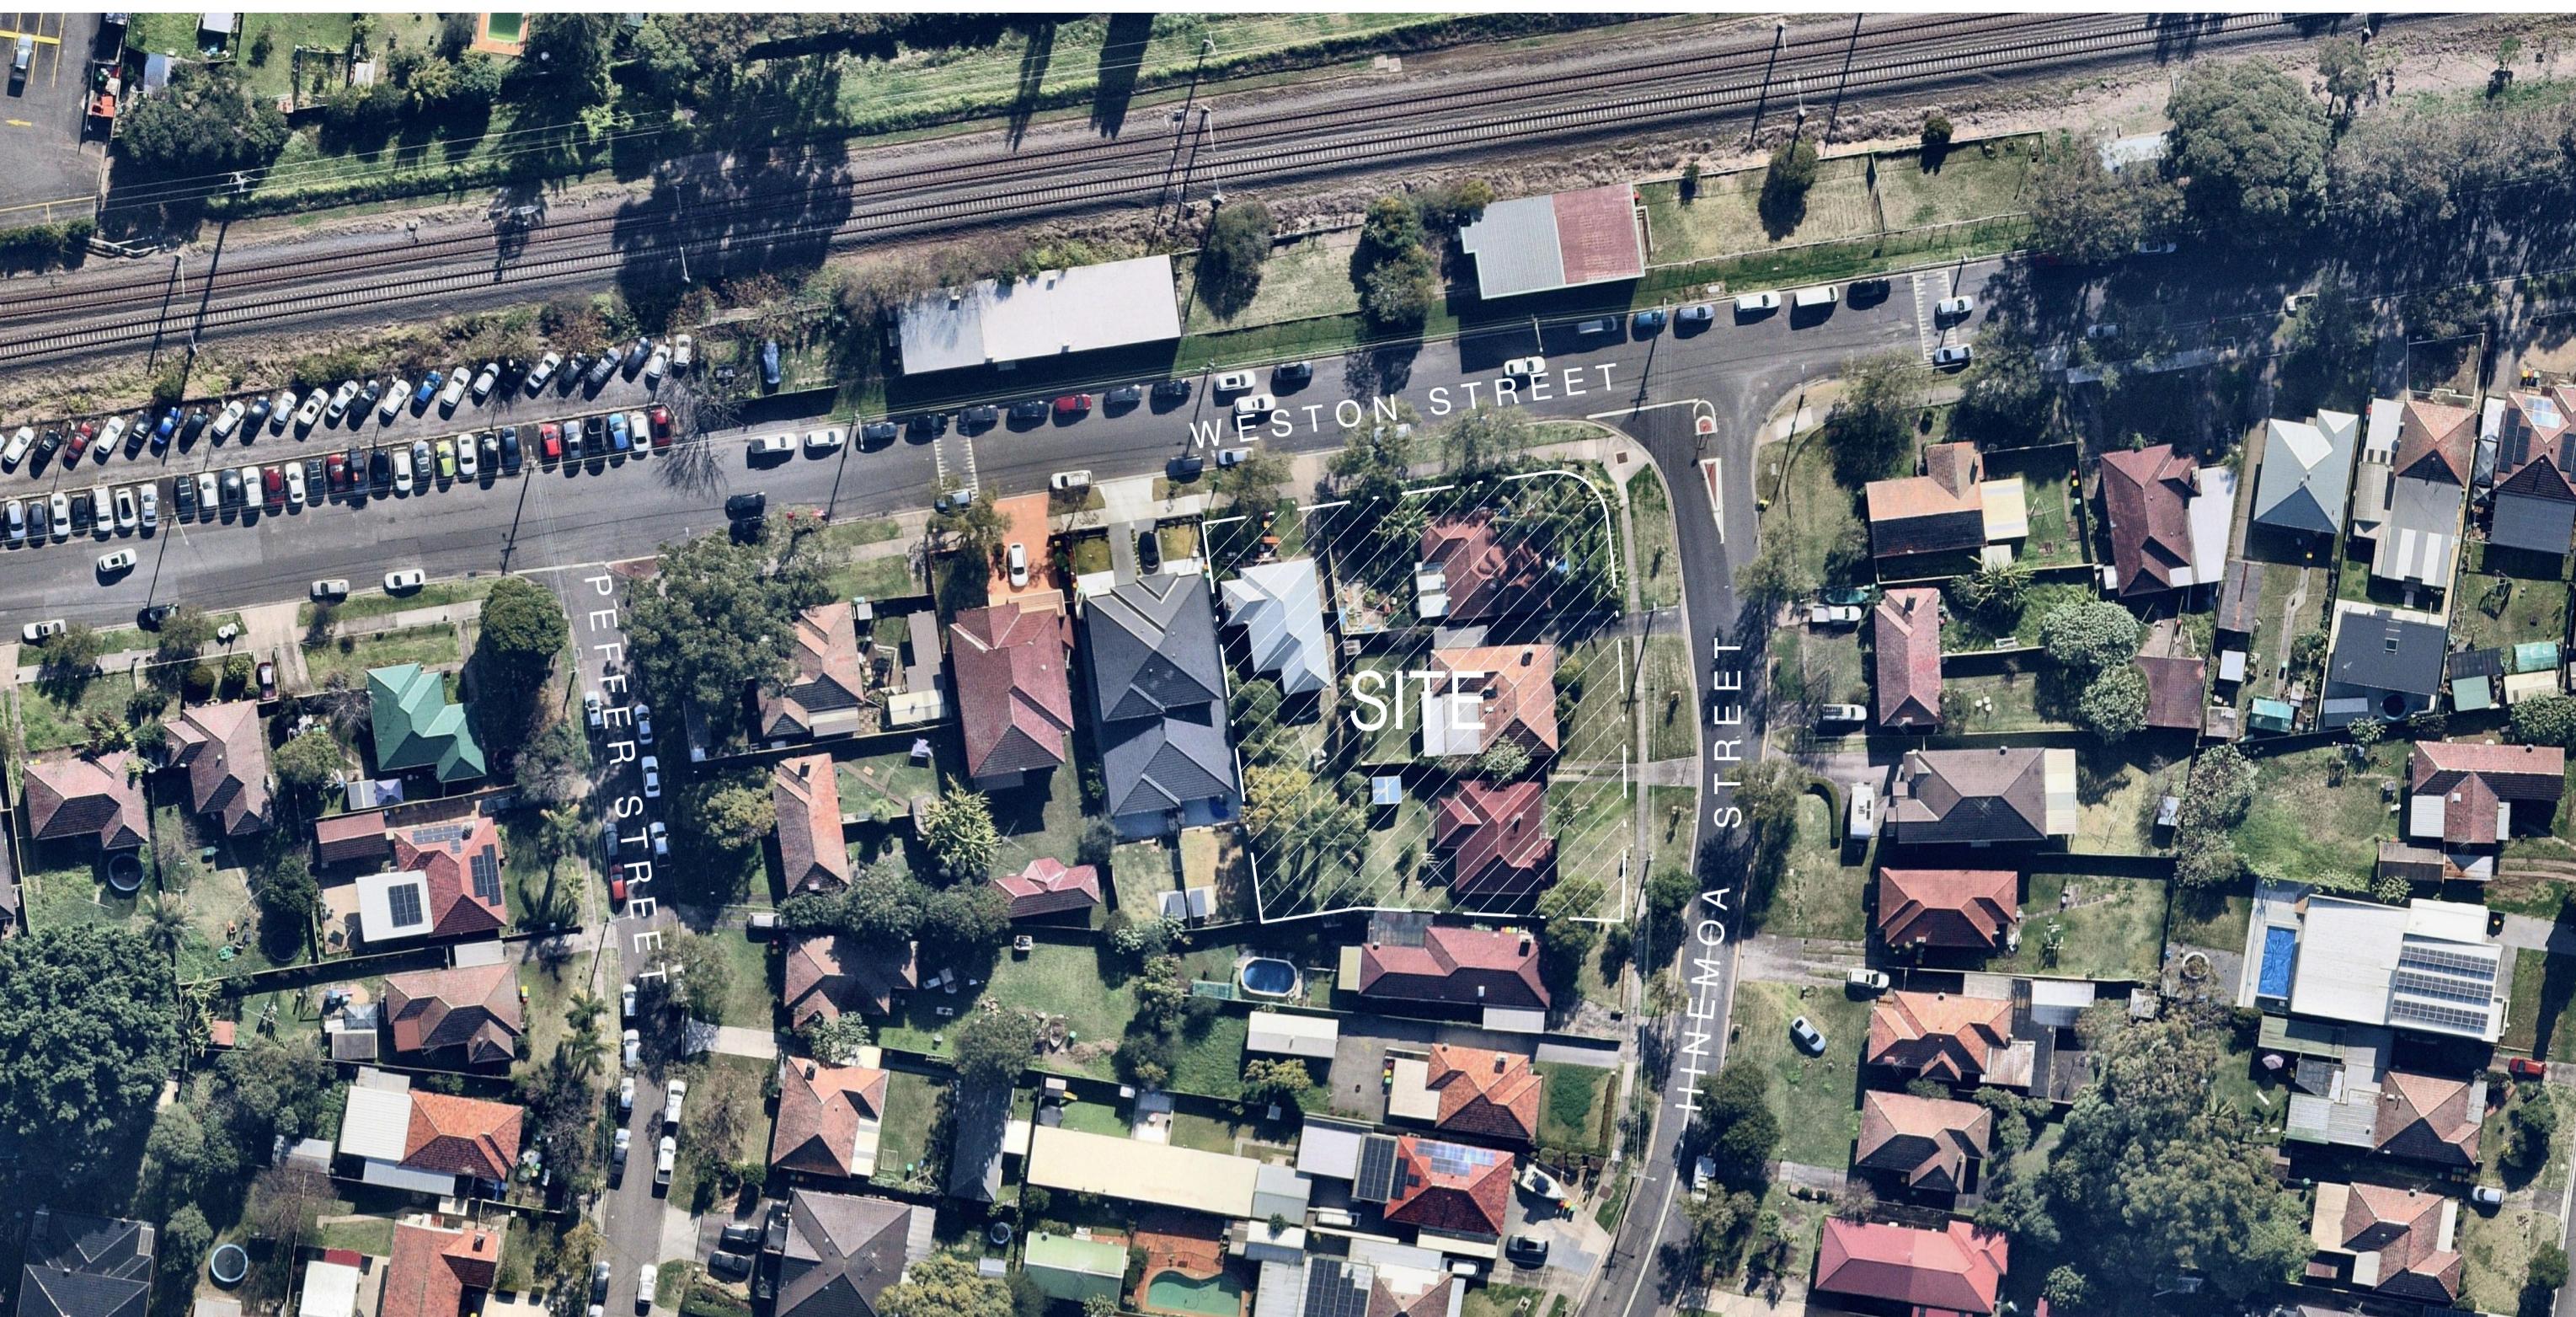

Compliance Summary (SEPP65-2015 Apartment Design Guide - Design Criteria & Objectives)

| Design Criteria | | Compliance | Proposal | Design Criteria | | Compliance | Proposal |
|-----------------|---|---|---|-----------------|--|--|--|
| 3D-1 | 1. Communal open space has a minimum area equal to 25% of the site area. | Yes | 1. The Common Open Space is 561m² / 25% of the site area. | 4D-1 | 1. Apartments are required to have the following minimum internal areas: | Yes | Internal apartment areas are in accordance with the design criteria and exceed the minimum internal floor areas required. |
| | 2. Developments achieve a minimum of 50% direct sunlight to the principal useable part of the communal open space for a minimum of 2 hours between 9 am and 3 pm on 21 June (mid winter). | No | The minimum internal areas include only one bathroom. Additional bathrooms increase the minimum internal area by 5m² each. | | Apartment type Minimum internal area Studio 3m² 1 bedroom 5m² 2 bedroom 7m² 3 bedroom 9m² | Yes | The local character comprises of predominantly post war monochromatic of low rise, low density single storey brick dwellings, austere detailed in a garden setting. The dwellings present simply detailed timber double hung corner windows to living rooms addressing the public domain. |
| 3E-1 | 1. Deep soil zones are to meet the following minimum requirements: | Yes | 1. Deep soil zones provided well exceed the minimum requirements. The site provides for a total area of 431 m² of deep soil zone or 19.0% of total site, wider than 6m. | 4D-2 | 1. Habitable room depths are limited to a maximum of 2.5 x the ceiling height | N/A | All units comprise a combined living, dining and kitchen |
| | | | 2. Every habitable room must have a window in an external wall with a total minimum glass area of less than 10% of the floor area of the room. Daylight and air may not be borrowed from other rooms. | | With qualifications - units 05, 15, 25 & 35 | Habitable room depths are in accordance with the design criteria. In relation to living rooms with an overall depth exceeding 8m units 05, 15, 25 & 35) the kitchen is located within 8m of the window, on this basis compliance is achieved. | |
| 3F-1 | Separation between windows and balconies is provided to ensure visual privacy is achieved. Min required separation distances from buildings to the side and rear boundaries are as follows: | Northern Setback: N/A as this is a street facing setback. Eastern Setback: N/A as this is a street facing setback. Western Setback: 6m from the building line to the side boundary complies. A minor 300mm balcony encroachment is proposed into the 6m zone for the purposes of built form articulation. An encroachment of 1m to the ground level terrace to unit 01, the encroachment is negated and is filled with landscaping. The terrace encroachment is sought in order to comply with ADG CI-4-1 & to build the terrace from the COS. Encroachments are minor and a considered to satisfy the intent of Part 5-1. | Building Height Habitable rooms and balconies Non-habitable rooms up to 12m (4 storeys) 6m 3m up to 25m (5-8 storeys) 9m 4.5m over 25m (9+ storey) 12m 6m | 4D-3 | 1. Master bedrooms have a minimum area of 10m² and other bedrooms to have 9m² (excluding wardrobe space) | Yes | All bedrooms achieve the minimum area requirements and are greater than 9m² & Master bedrooms are greater than 10m². |
| | | | 2. Bedrooms have a minimum dimension of 3m (excl. wardrobe space) | | Yes | All bedrooms exceed or are equal to the minimum dimension of 3m. | |
| | | | 3. Living rooms or combined living/dining rooms have a minimum width of: 3.6m for studio and 1 bed apartments 4.4m for 2 and 3 bedroom apartments | | Yes | All living rooms to 2 bedroom apartments are at least 4m wide. All Living Rooms to 1 Bedroom Apartments are at least 3.6m wide. | |
| 4A-1 | 1. Living rooms and private open spaces of at least 70% of apartments in a building receive a minimum of 2 hours direct sunlight between 9 am and 3 pm at mid winter in the Sydney Metropolitan Area and in the Newcastle and Wollongong local government areas. 3. A maximum of 15% of apartments in a building receive no direct sunlight between 9 am and 3 pm at mid winter | Yes | 1. 78.6% [33-42] of apartments receive 2 hours of direct sunlight. | 4E-1 | 1. All apartments are required to have primary balconies as follows: | Yes | 1. Balconies provided to apartments are in accordance with this design criteria. |
| | | | 2. Apartments at ground level or on a podium or similar structure, a private open space is provided instead of a balcony. It must have a minimum area of 15m² and a minimum depth of 3m | | 2. Dwellings type Minimum area Minimum depth Studio apartments 4m² - 1 bedroom apartments 8m² 2m 2 bedroom apartments 10m² 2m 3+ bedroom apartments 12m² 2.4m | Yes | 2. Terraces provided to apartments are in accordance with this design criteria. |
| 4B-3 | 1. At least 60% of apartments are naturally cross ventilated in the first nine storeys of the building. Apartments at ten storeys or greater are deemed to be cross ventilated only if any enclosure of the balconies at these levels allows adequate natural ventilation and cannot be fully enclosed. 3. Overall depth of a cross-over or cross-through apartment does not exceed 18m; measured glass line to glass line | Yes | 1. 61.9% [26-42] of apartments are cross-ventilated | 4F-1 | 1. The maximum number of apartments off a circulation core on a single level is eight 2. For buildings of 10 storeys and over, the maximum number of apartments sharing a single lift is 40 | Yes | 1. The building floor plate comprises 2 x cores featuring 2 lifts and stair wells. Although the floor plates are joined by a corridor. Each separate core provides access to less than 8 units i.e. 6 (block B-Weston St) and 4 (block A-Hinemaa St) apartments, by the provision of two lifts and stairs it is considered that this criteria is achieved. |
| | | N/A | | | n/a | | |
| 4C-1 | Measured from finished floor level to finished ceiling level; minimum ceiling heights are: | Yes | Minimum ceiling heights are in accordance with the design criteria, to ensure the design is capable of compliance the floor to floor heights have been set at 3.15m. | 4G-1 | 1. In addition to storage in kitchens, bathrooms and bedrooms, the following storage is provided: | Yes | All apartments have been allocated storage in the basement and in the apartments. The storage volumes provided exceed the minimum requirements. |
| | | | | | Apartment type Storage size volume Studio 4m² 1 bedroom 6m² 2 bedroom 8m² 3+ bedroom 10m² | | Apartments 02 and 03 do not achieve 50% of the storage requirement within the apartment, however this variance is minor at approximately 20%. Given that the storage provision provided to all the apartments exceeds the minimum requirement, this is considered a very minor deviation from this control and on balance should be considered an acceptable outcome in achieving the objectives of this clause. |
| | | | At least 50% of the required storage is to be located within the apartment | | | | |

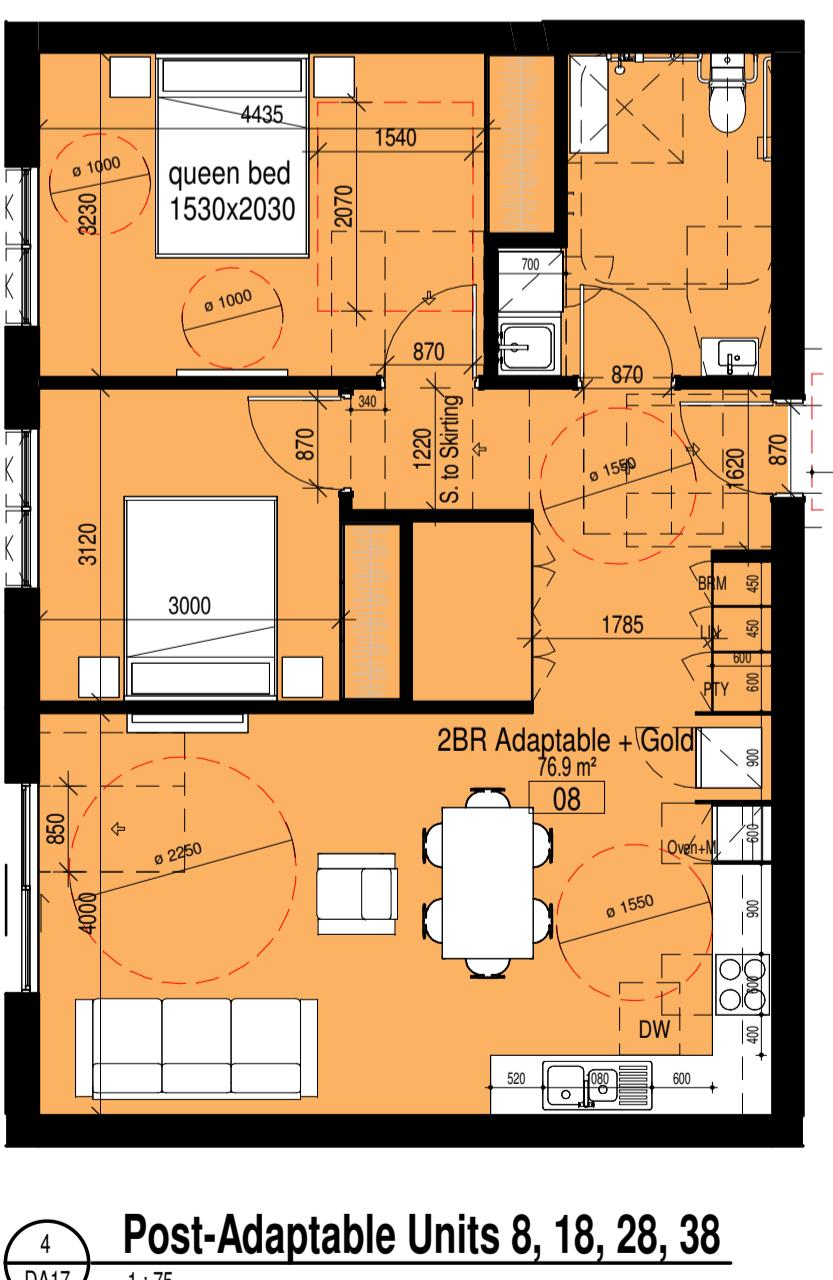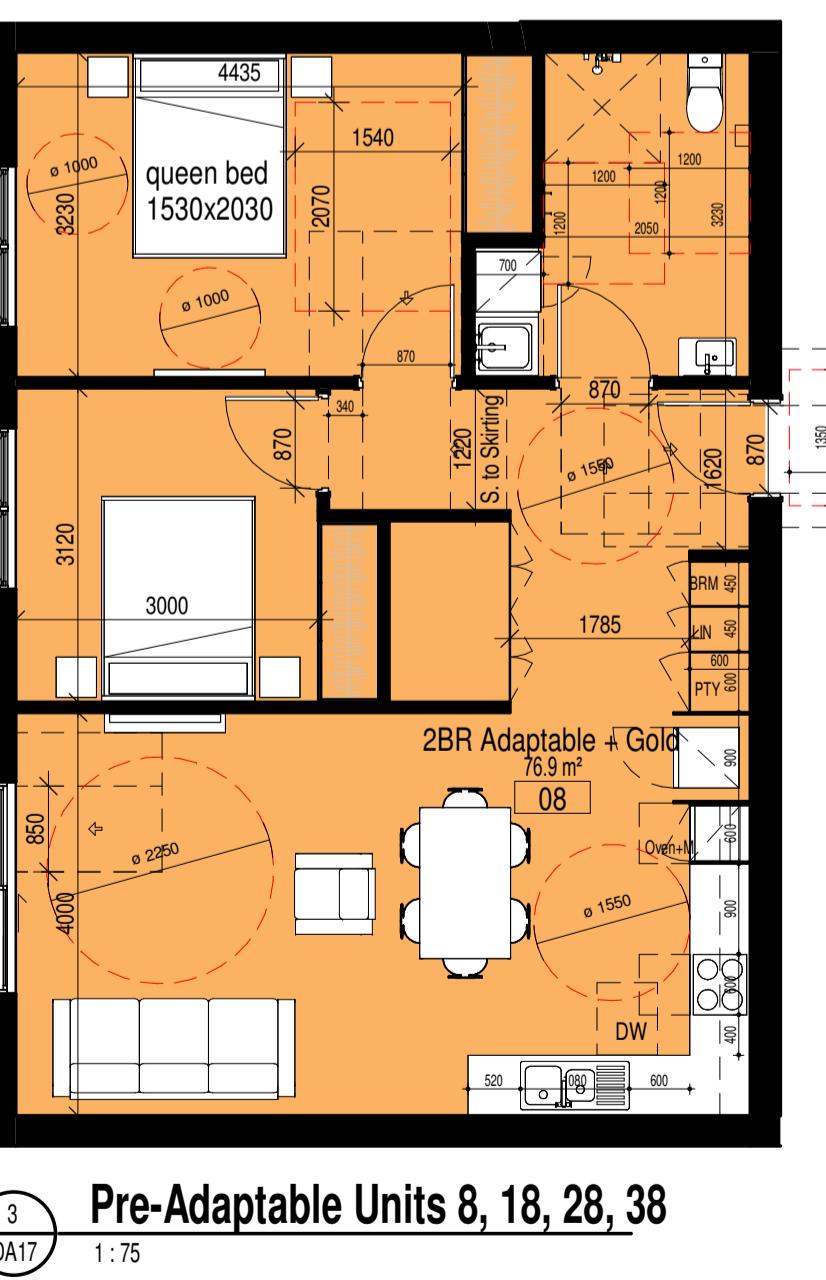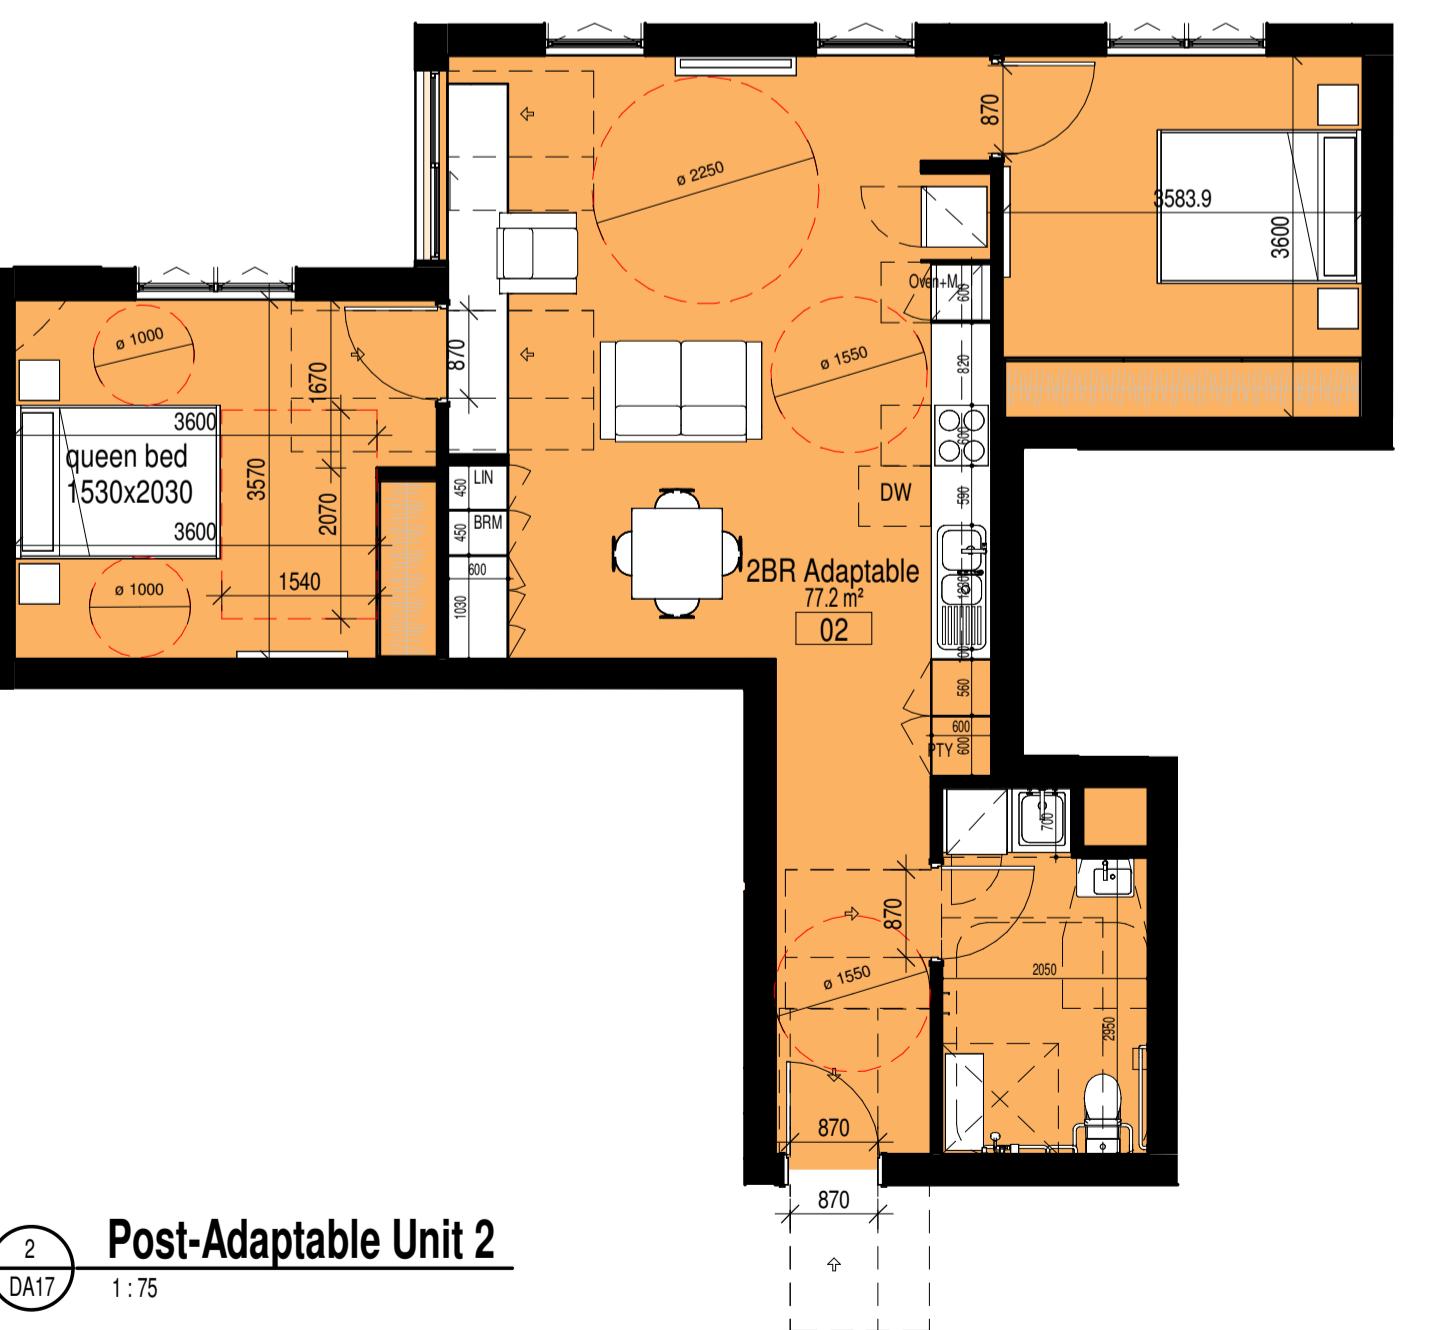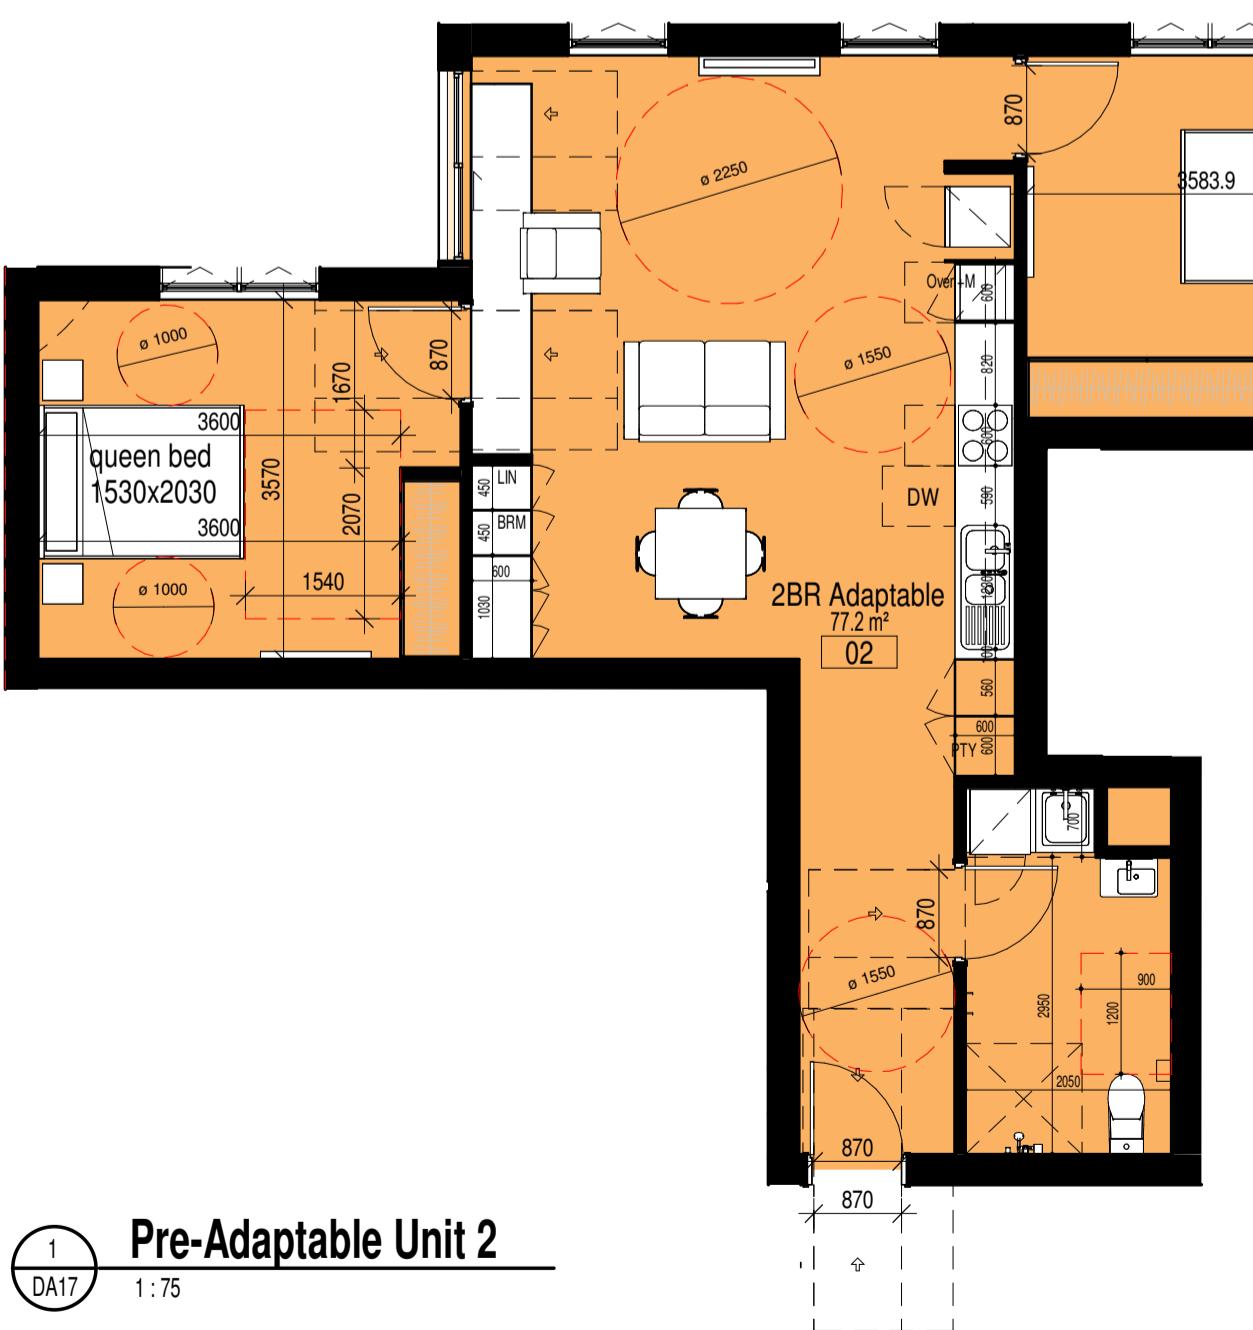

| ISSUE | DATE | AMENDMENT | Note | |
|-------|------------|-----------|------|--|
| A | 2024-08-30 | DA ISSUE | | |
| | | | DA17 | |



PROJECT
PANANIA - LAHC 2021/505
ADDRESS
171 Weston St & 2-6 Hinema St, Panania, NSW, 2213
LOT 42, 43, 44, 45 / DP35211

CLIENT
NSW LAHC
LOCKED BAG 5022
171 Weston St & 2-6 Hinema St, Panania, NSW, 2213
PHONE 1800 738 718

PROJECT No.
21042
CLIENT
LAHC

MORSON
GROUP

NOMINATED ARCHITECT - P.F.
NSW GOVERNMENT
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PO Box 170, Port Point, NSW 1335

SHEET
NAME: DESIGN PRINCIPLES & ADG COMPLIANCE
SCALE: 1:75

DRAWING No.
DA02
ISSUE No.
A



CORNER AT HINEMOA - WESTON STREET

| ISSUE | DATE | AMENDMENT |
|-------|------------|-----------|
| A | 2024-08-30 | DA ISSUE |
| | | |

NOTE:
The 3D visualisations shown herein are considered an artists impression intended to communicate design intent only. The accuracy of elements shown in these images, including site context, may not be modelled accurately. Refer to site survey as well as architectural plans, sections and elevations for more detailed information.

PROJECT
PANANIA - LAHC 2021/505
CLIENT
NSW LAHC
ADDRESS
171 Weston St & 2-6 Hinemoa St, Panania, NSW, 2213
LOT 42, 43, 44, 45 / DP35211

PROJECT No.
21042
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LAHC

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MORSON GROUP

DA03

DRAWING No.

ISSUE No.

A

SHEET NAME: **3D VIEWS - SHEET 1**
SHEET SIZE: A1
SCALE:



HINEMOA STREET



WESTON STREET



HINEMOA STREET



COURTYARD

| ISSUE | DATE | AMENDMENT | NOTE: |
|-------|------------|-----------|---|
| A | 2024-08-30 | DA ISSUE | The 3D visualisations shown herein are considered an artists impression intended to communicate design intent only. The accuracy of elements shown in these images, including site context, may not be modelled accurately. Refer to site survey as well as architectural plans, sections and elevations for more detailed information. |
| | | | |

24/2/2025 17:33:05 C:\Users\clarl\MG Dropbox\MGP\PROJECTS\PANANIA\21042 - LAHC GH\Architecture\CAD\21042_171 Weston St, Panania_20250220_CC.rvt

PROJECT
PANANIA - LAHC 2021/505
CLIENT
NSW LAHC
ADDRESS
171 Weston St & 2-6 Hinemoa St, Panania, NSW, 2213
LOT 42, 43, 44, 45 / DP35211

PROJECT No.
21042
CLIENT
NSW
GOVERNMENT

21042
NOMINATED ARCHITECT - P.F.
ACN 139 480 056, ABN A139 480 056
NSW GOVERNMENT
LOCKED BAG 5022
PARAMATTA NSW 2124
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MORSON
GROUP

SHEET NAME: 3D VIEWS - SHEET 2
SIZE: A1
SCALE:
DRAWING No. DA04
ISSUE No. A



PREDOMINANT BLOCK AND LOT PATTERNS

Most of the lots tend to be rectangular shaped. However, almost all of them are irregular shaped and it is not easy to find many similar plots. This pattern varies due to the irregular structure of the urban fabric and roads.

LOT CHANGE OVER TIME

There have been no relevant changes in lots shape and size over time. Basically, the structure of the area is almost the same than when it was urbanized around half century ago. Most of the buildings are detached residential dwellings. Some exceptions exist where medium density residential buildings have been developed and lots amalgamated.

TYPICAL LOT SIZES, SHAPE AND ORIENTATION

The typical lot tends to be rectangular shaped at around 600m². Some of them are irregular shaped, but even on those cases they tend to be rectangular shaped. Orientation may vary depending on the road structure due it is quite irregular in shape. Therefore we are not able to consider there is a predominant orientation.

BEST LOTS FOR INTENSIFICATION

Best lots for high density residential intensification are those located along main roads, close proximity to bus stops and railway station & of regular shape. Intensification in irregular or regular shaped lots for high density will require lot amalgamation.


LOT AMALGAMATION

Lot amalgamation is necessary to support future development. Most of the lots are irregular shaped and it will be more efficient to join lots in order to take advantage of the site as much as possible. Additionally, setbacks restrictions will be easier to comply in big lots.

MOST SUITABLE SITES FOR INTENSIFICATION

Corner sites and sites with two street frontages, as well as non excessively deep sites, are more suitable for amalgamation and intensification. On the other hand, narrow and deep sites will be less suitable due to most of the units will face side setbacks instead of the main street.

| ISSUE | DATE | AMENDMENT | |
|-------|------------|-----------|--|
| A | 2024-08-30 | DA ISSUE | |
| | | | |

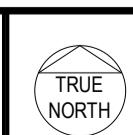

0 5 10 15 20

50m

SCALE 1:500@A1
(1:1000@A3)



PROJECT PANANIA - LAHC 2021/505
CLIENT NSW LAHC
ADDRESS PO BOX 5022, PARAPAMATTA NSW 2124
LOT 42, 43, 44, 45 / DP35211

PROJECT No. 21042
CLIENT LAHC
NSW GOVERNMENT

NOMINATED ARCHITECT - P F MORSON REGISTRATION NUMBER 8103
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PO Box 170, Potts Point, NSW 1133

SHEET SIZE: A1
NAME: BLOCK ANALYSIS STUDY
SCALE: 1:500

DRAWING No. DA06
ISSUE No. A

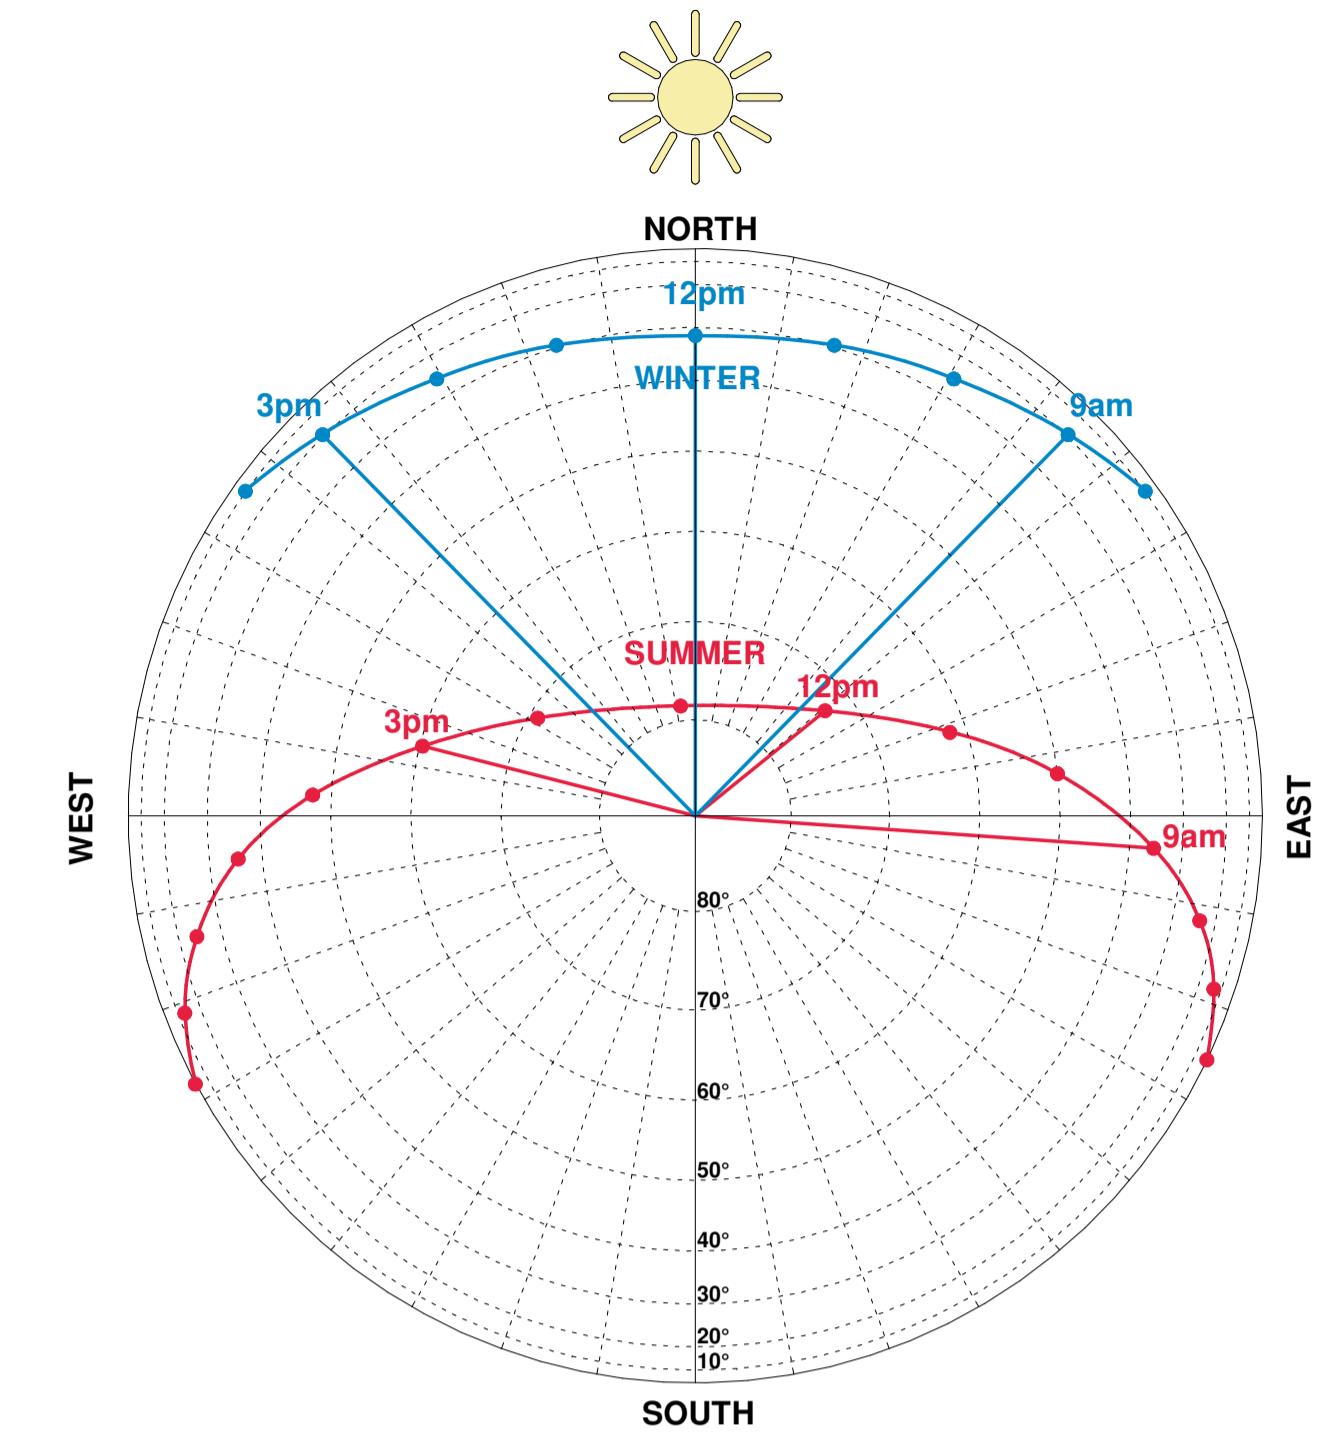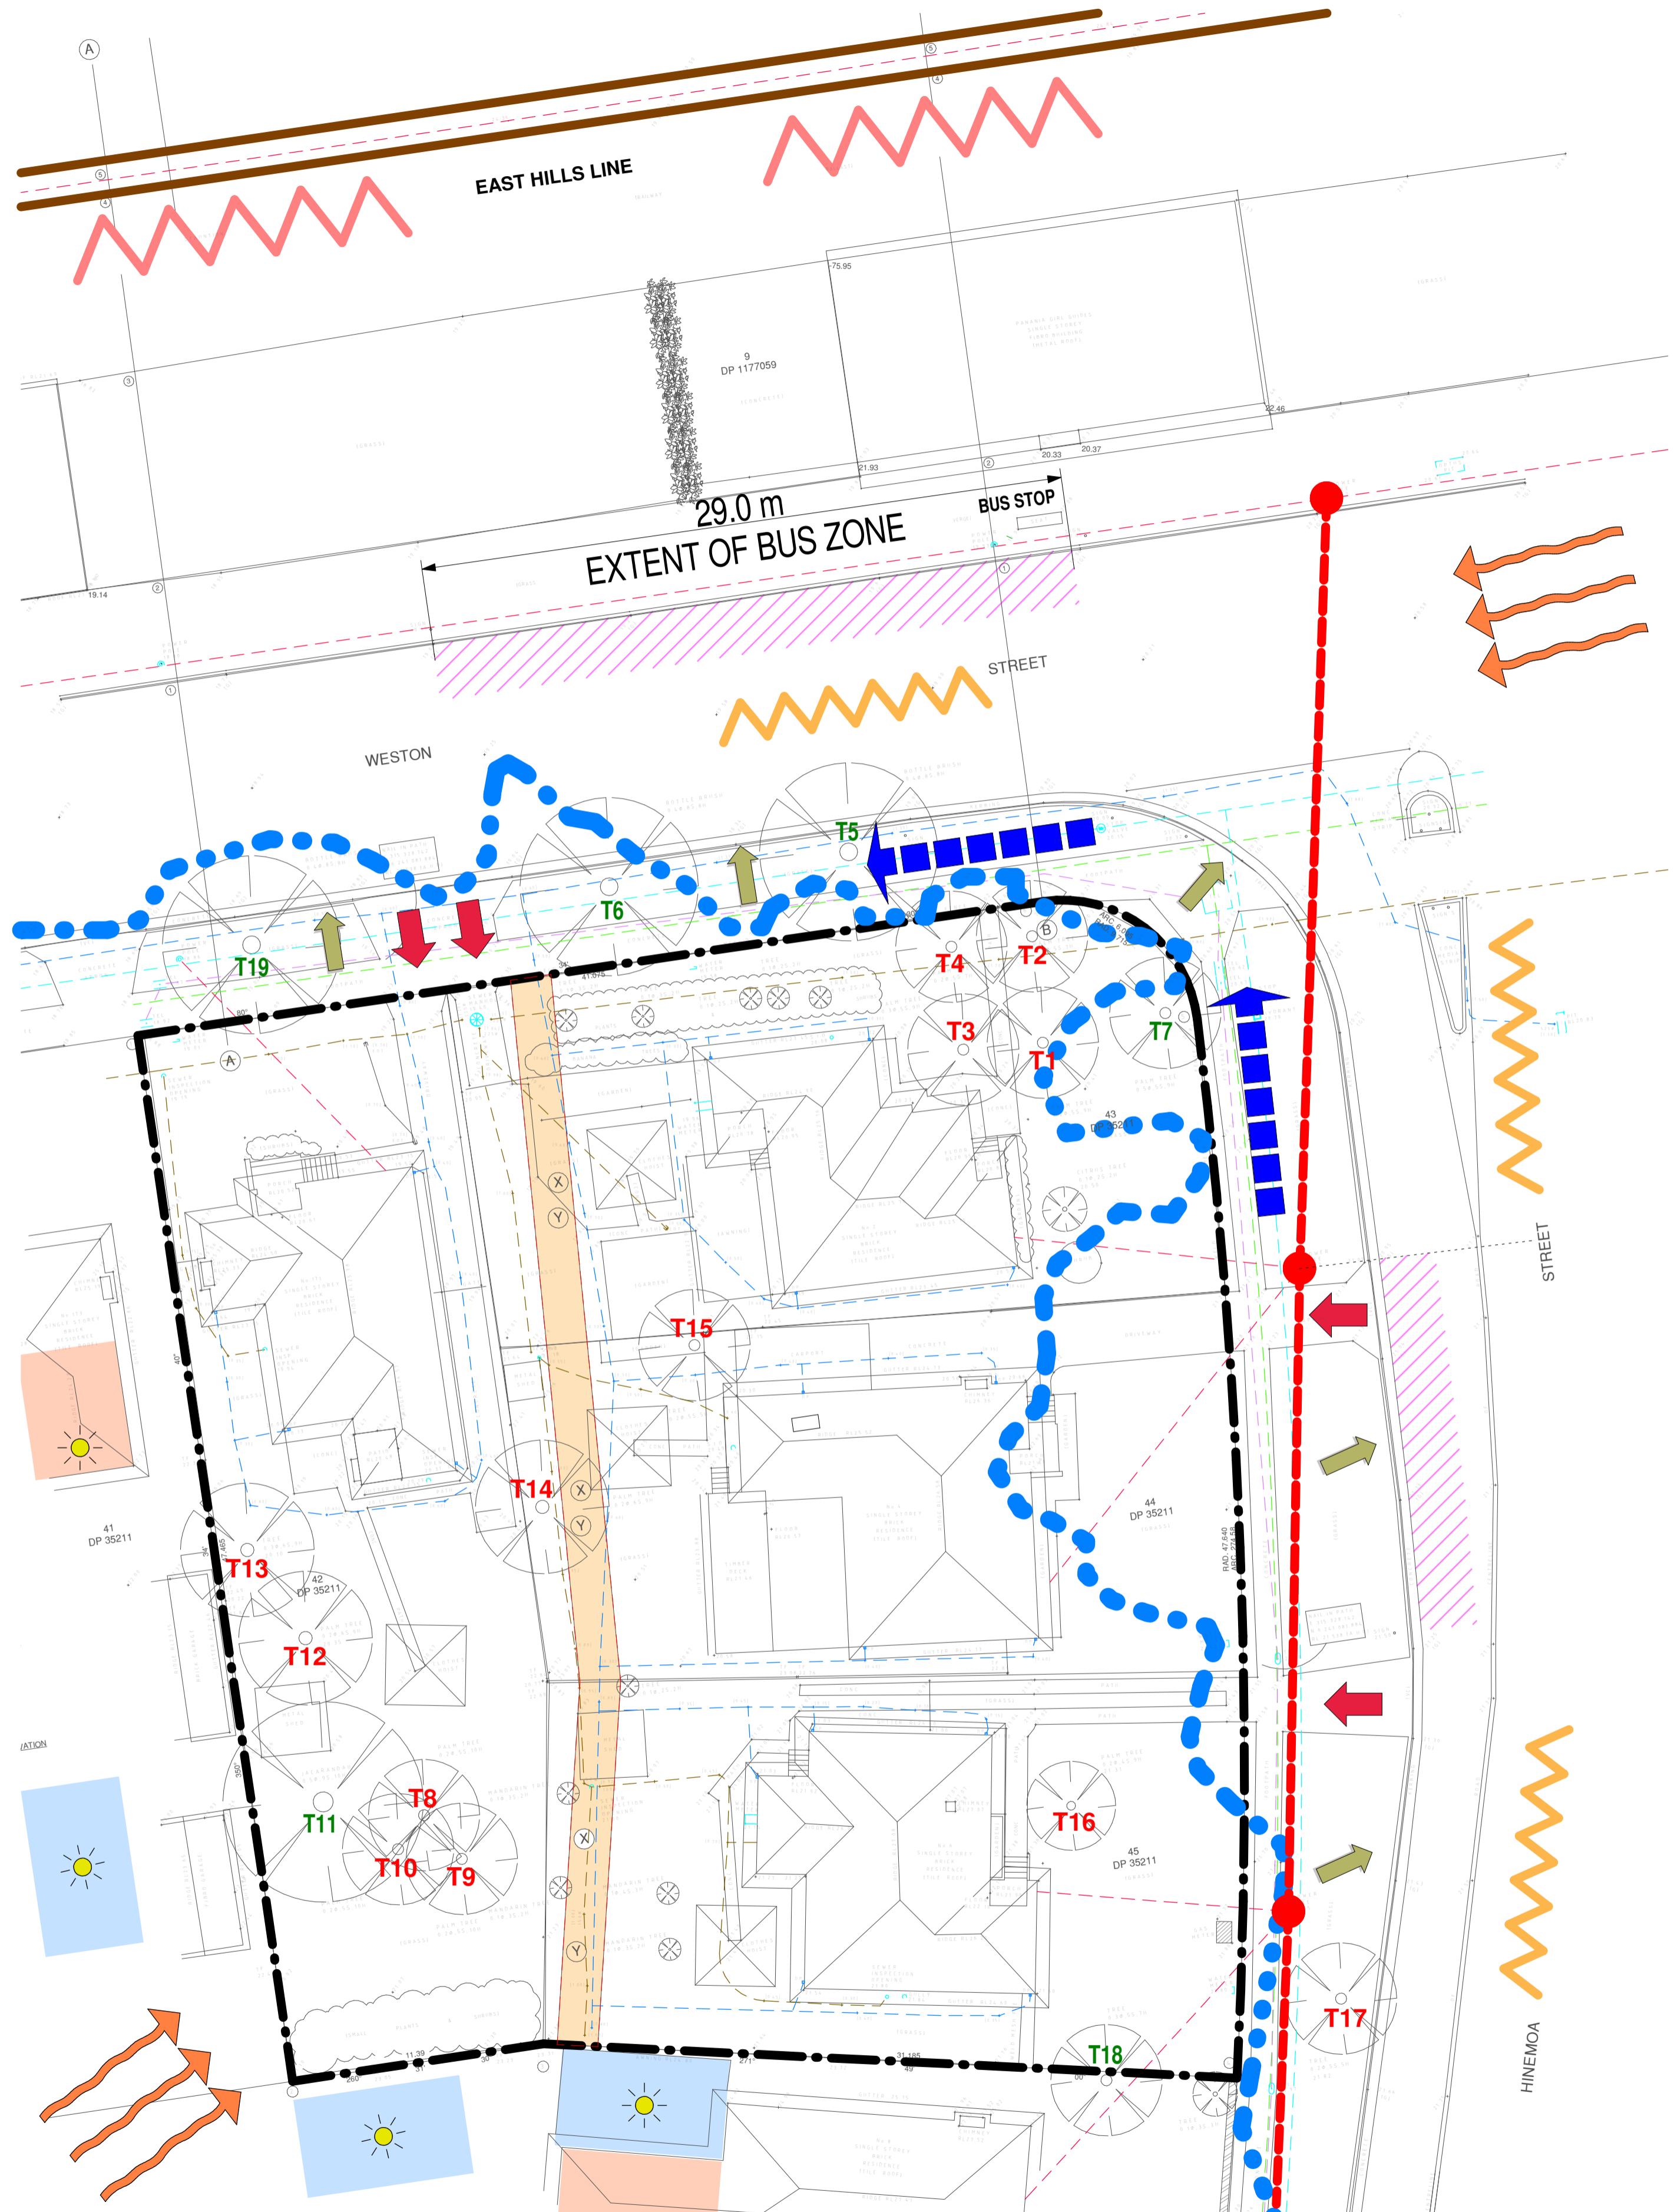

| SITE ANALYSIS LEGEND | |
|--|-----------|
| Views Out | ◀ |
| Ventilation Path | ↔ |
| Subject Site: Communal Open Space | ■ |
| Adjoining Site: Private Open Space | □ |
| Habitable Living rooms | ■ |
| Receives > 3hrs of sunlight 9am & 3pm on 21st June | ○ |
| Receives > 3hrs of sunlight 9am & 3pm on 21st June | ○ |
| Sources of Noise (Less/More) | ~~~~~ |
| Winds | ~~~~~ |
| Vehicular Entry | ◀ |
| Pedestrian Entry | ↔ |
| High light overhead power lines | - - - - - |
| Existing Drainage Easement | ■■■■■ |
| Existing Tree Removal | T# |
| Medium Risk Area Flood Impact | - - - - - |
| Extent of Bus Zone | ■■■■■ |
| High Pedestrian Movements Towards Train Station | ■■■■■ |
| Existing Stormwater | - - - - - |
| Existing Water services | - - - - - |
| Existing Gas services | - - - - - |
| Existing Telecom (DBYD) | - - - - - |
| Railway | — |

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| ISSUE | DATE | AMENDMENT | |
|-------|------------|-----------|--|
| A | 2024-08-30 | DA ISSUE | |
| | | | |



TRUE
NORTH



0 5 10 15 20m
SCALE 1:200@A1
(1:400@A3)

PROJECT PANANIA - LAHC 2021/505
CLIENT NSW GOVERNMENT
ADDRESS 171 Weston St & 2-6 Hinemoa St, Panania, NSW, 2213 PARRAMATTA NSW 2124
PHONE 1800 738 718
LOCKED BAG 5022
LOT 42, 43, 44, 45 / DP35211

PROJECT No. 21042
CLIENT LAHC
MORSON GROUP
NOMINATED ARCHITECT - P F MORSON REGISTRATION NUMBER 8100
ACN 159 480 056, ABN 41 159 480 056
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PO Box 170, Potts Point, NSW 1335

SHEET SIZE: A1 SHEET NAME: SITE ANALYSIS
SCALE: 1:200

DRAWING No. DA07
ISSUE No. A

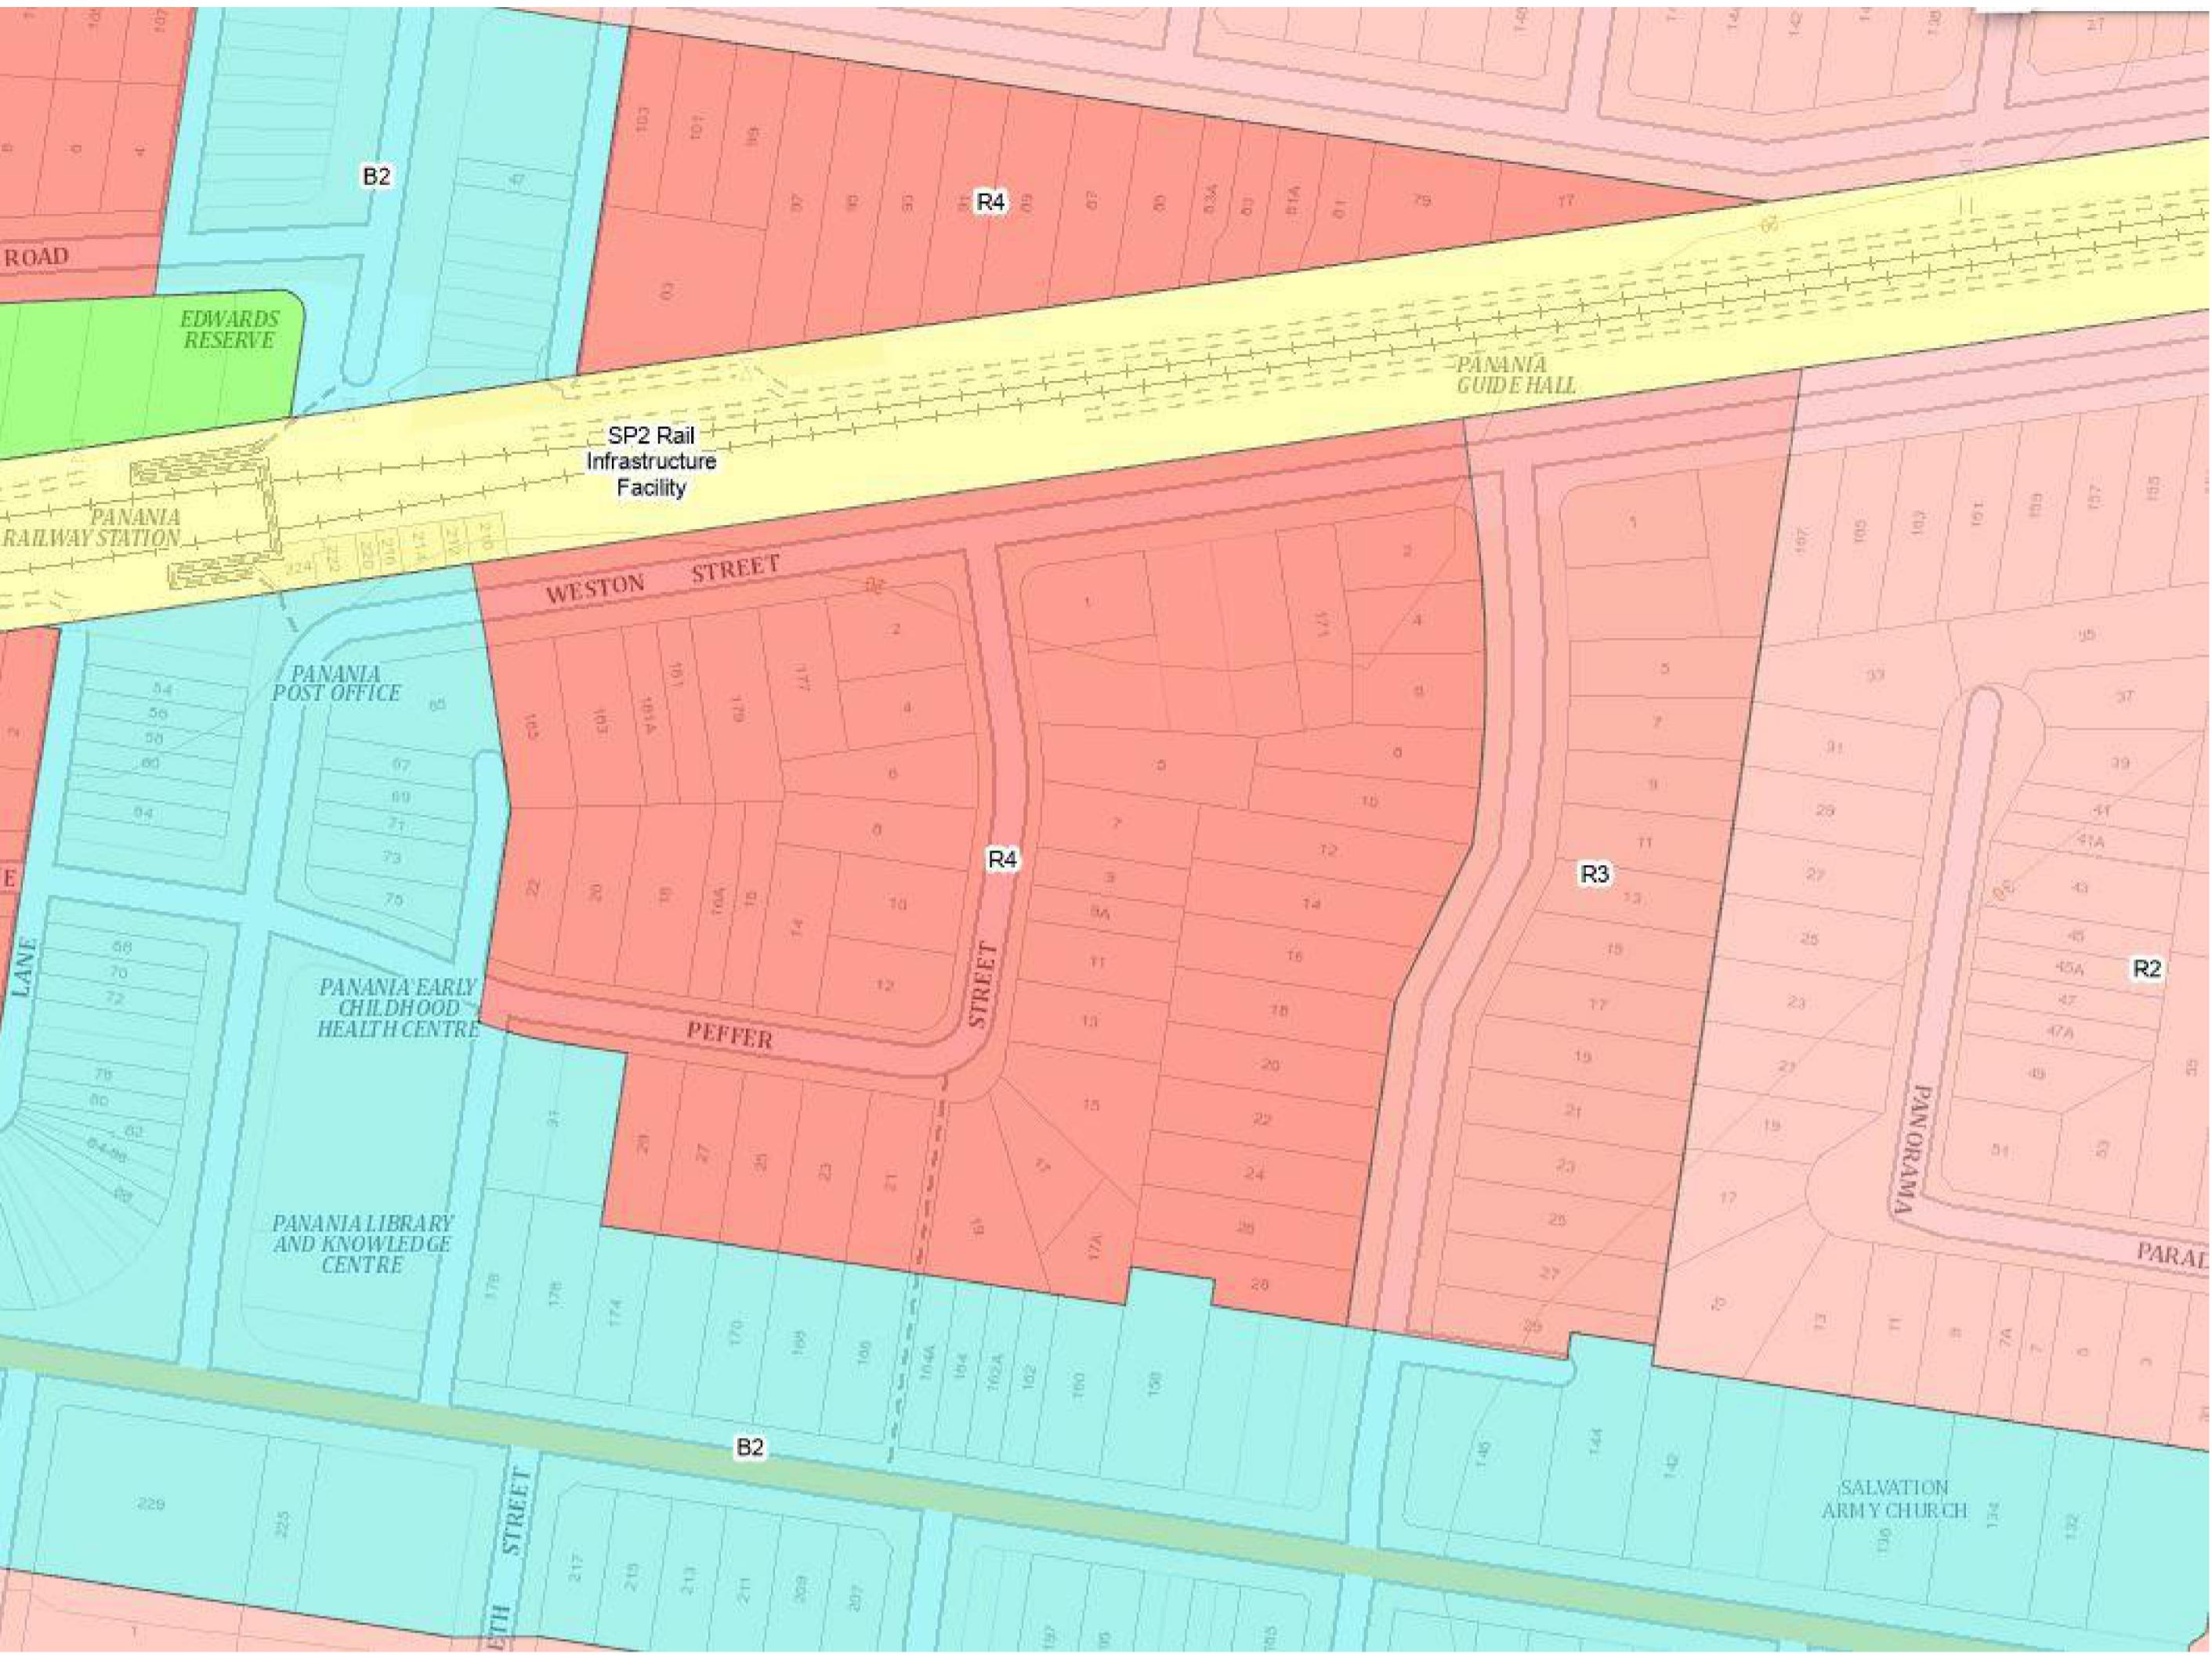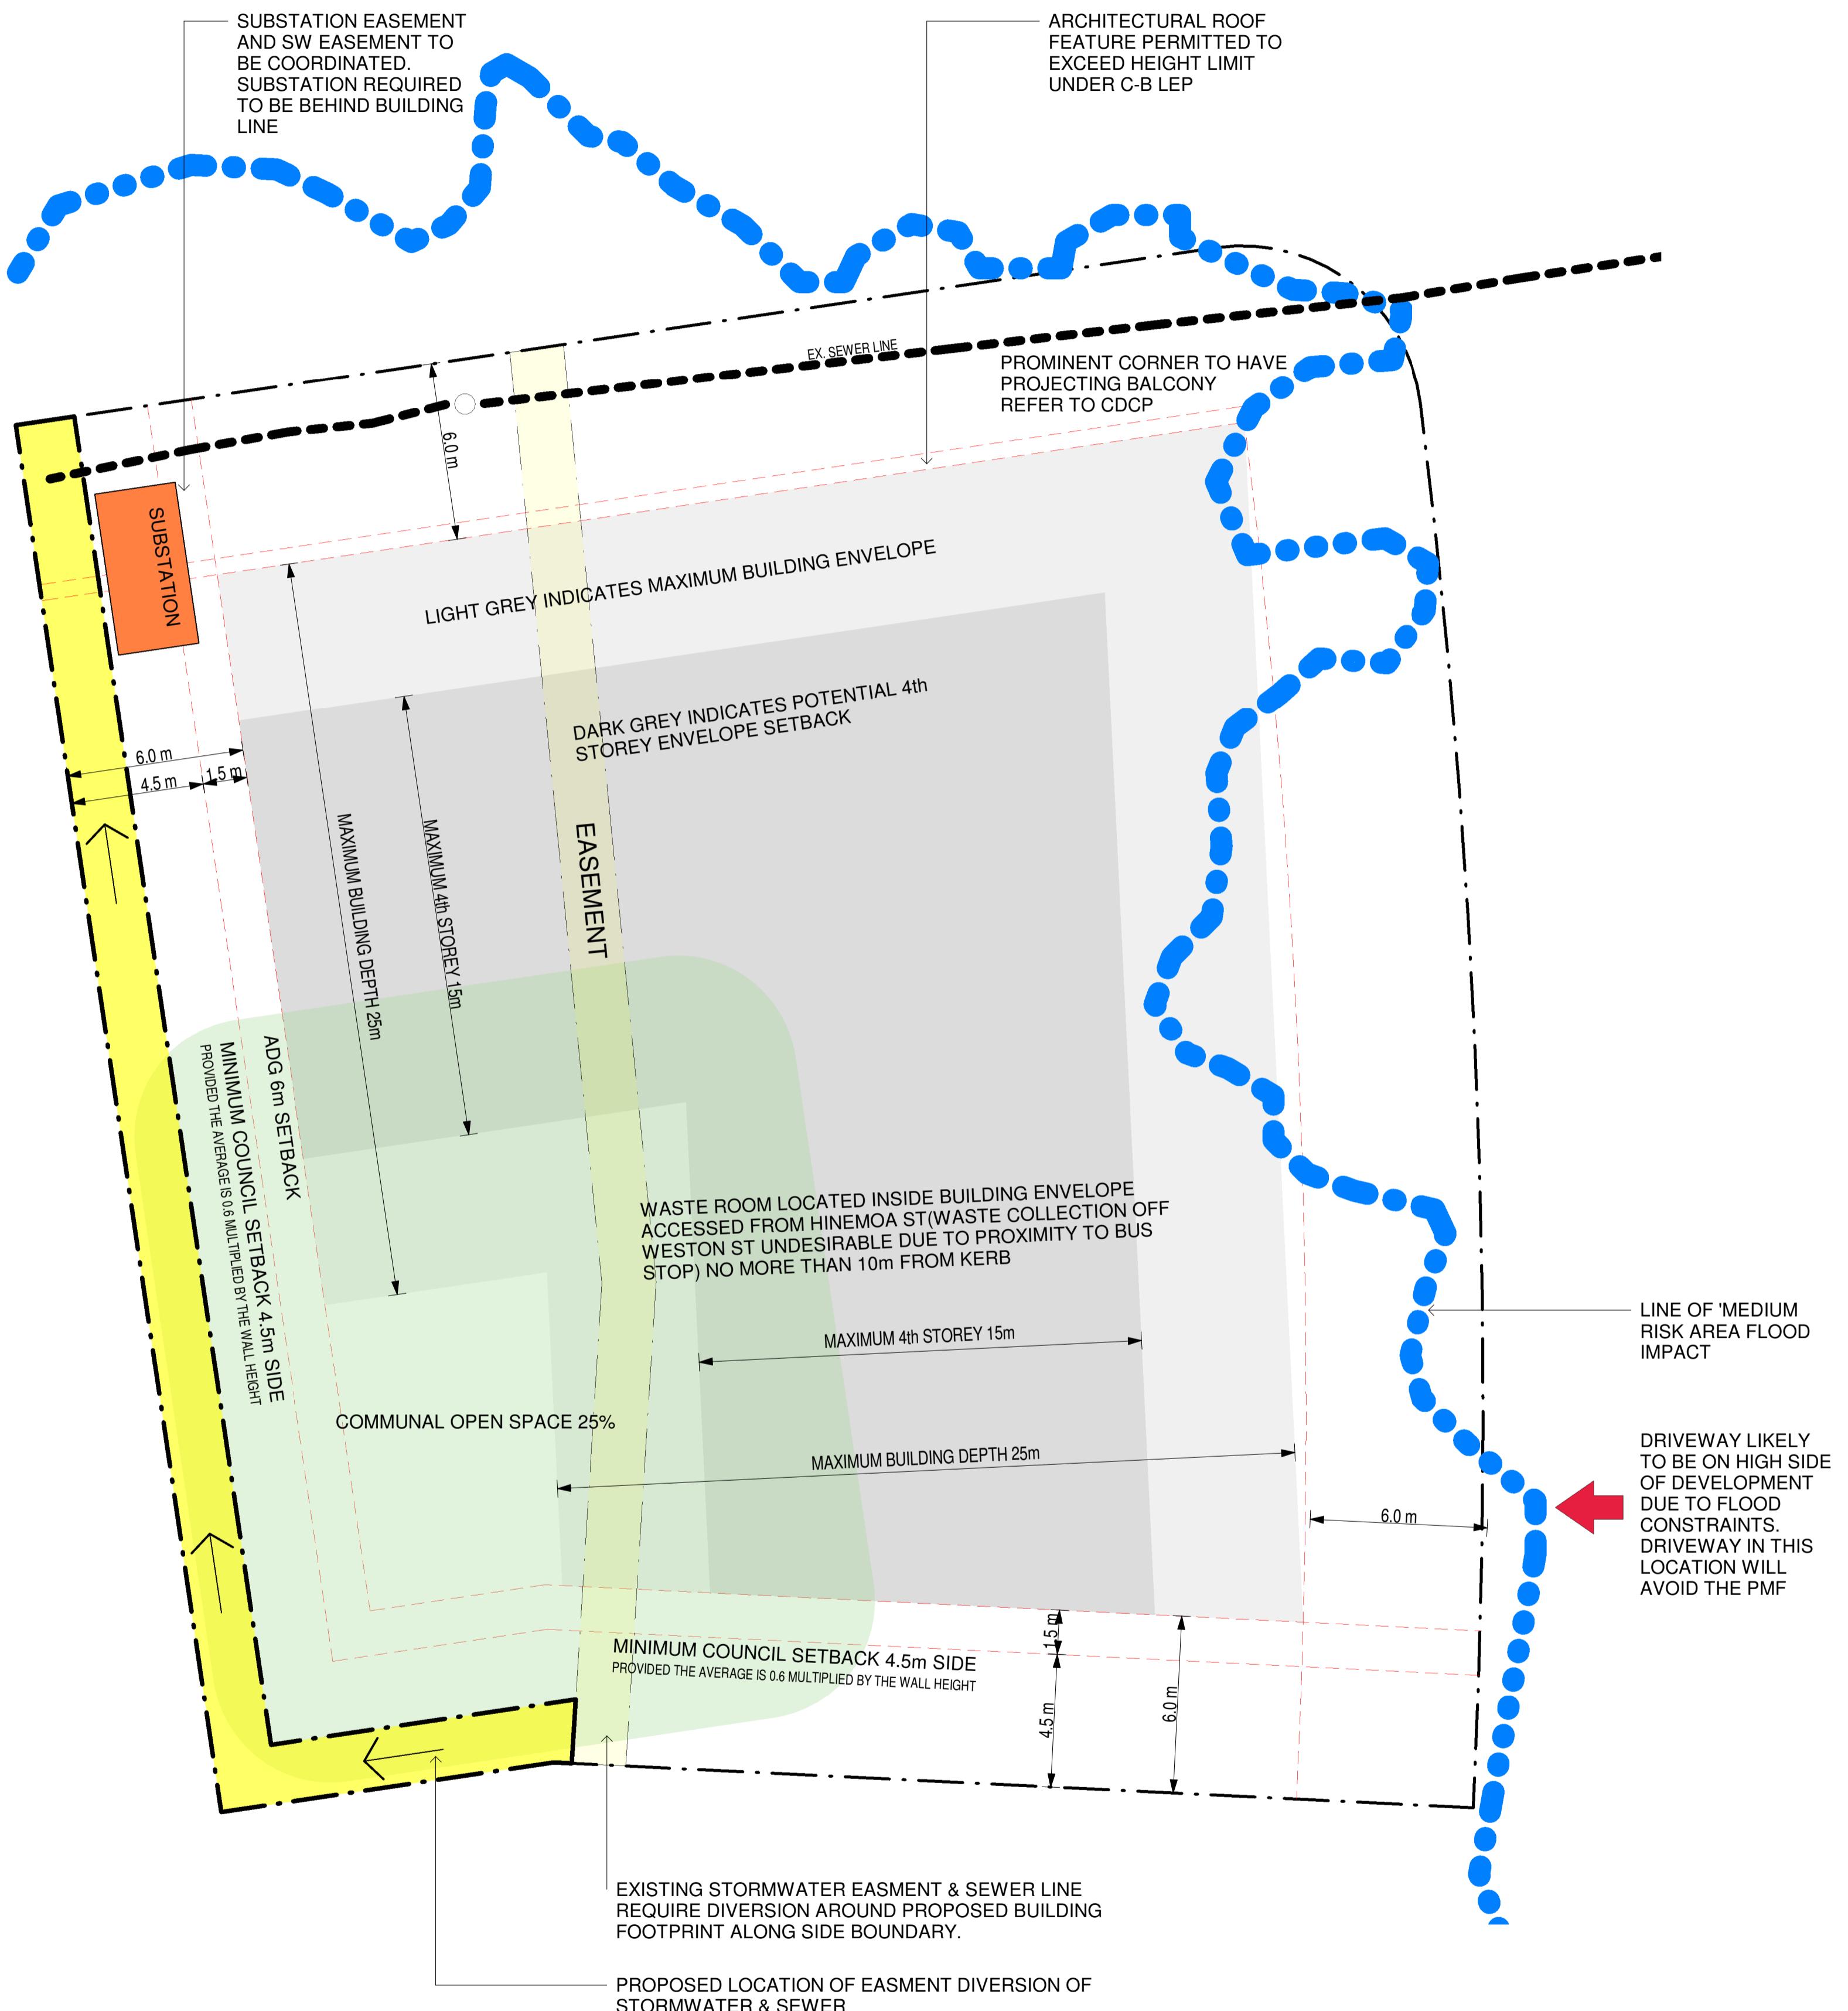

| ISSUE | DATE | AMENDMENT | |
|-------|------------|-----------|------------|
| A | 2024-08-30 | DA ISSUE | |
| | | | TRUE NORTH |



PROJECT
PANANIA - LAHC 2021/505
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CLIENT
NSW LAHC
LOCKED BAG 5022
171 Weston St, Panania, NSW 2213
PHONE 1800 738 718

PROJECT No.
21042

NSW GOVERNMENT

MORSON GROUP

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SCALE:
1:150

SITE ANALYSIS PLAN - DEVELOPMENT CONDITIONS

DRAWING No.
DA08
ISSUE No.
A



| ISSUE | DATE | AMENDMENT |
|-------|------------|-----------|
| A | 2024-08-30 | DA ISSUE |
| B | 2025-02-24 | DA MODS. |



0

5

10

15

20m

(1:400@A3)

PROJECT
PANANIA - LAHC 2021/505
CLIENT
NSW LAHC
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171 Weston St & 2-6 Hinemoa St, Panania, NSW, 2213
PARRAMATTA NSW 2124
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PROJECT No.
21042
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NOMINATED ARCHITECT - P F
MORSON GROUP PTY LTD
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PO Box 170, Potts Point, NSW 1135

SHEET
NAME: SITE PLAN
SCALE:
1:200


DRAWING No.
DA09
ISSUE No.
B




2 Hinemoa St



4-6 Hinemoa St

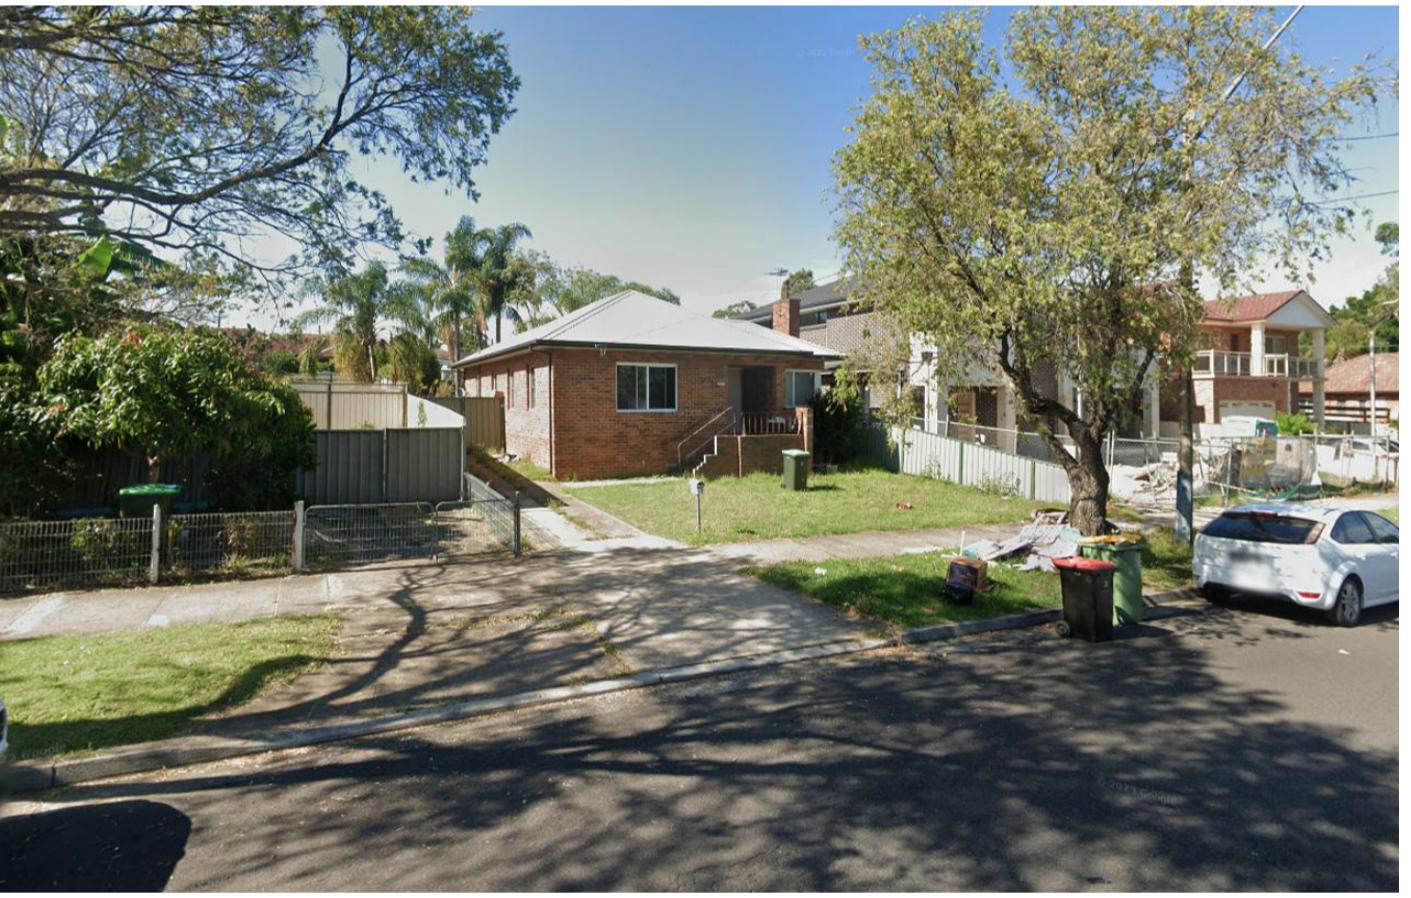

171 Weston

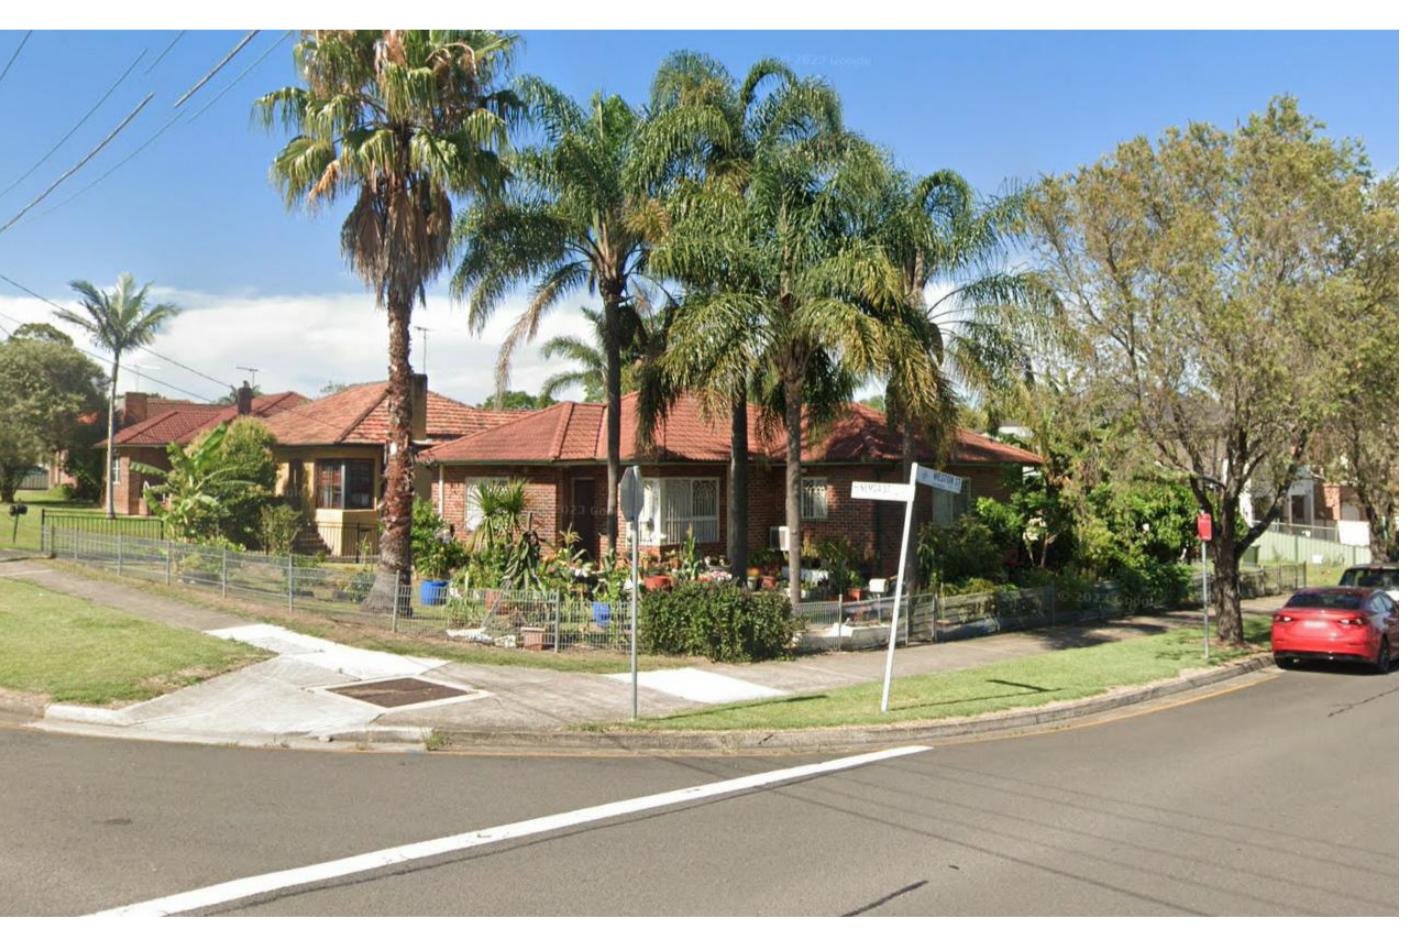

Weston Hinemoa Corner

1. THE CONTRACTOR SHALL IMPLEMENT EROSION AND SEDIMENT CONTROL MEASURES TO THE COUNCIL'S SPECIFICATION PRIOR TO THE COMMENCEMENT OF CONSTRUCTION AND DURING CONSTRUCTION.

2. ALL EROSION & SEDIMENT CONTROL DEVICES SHALL BE MAINTAINED IN A SATISFACTORY WORKING ORDER DURING THE CONSTRUCTION PERIOD. INSPECTIONS OF THESE DEVICES SHALL BE CARRIED OUT AFTER EACH STORM. REPAIRS AND/OR DE-CLOGGING SHALL BE CARRIED OUT TO ENSURE PROPER OPERATION OF THE DEVICE.



3. STORAGE OF MATERIALS AND EQUIPMENT SHALL BE WITHIN SEDIMENT CONTROLLED AREAS.

4. REMOVE SILT STOP FENCING AND DRAINAGE STRUCTURE SEDIMENT CONTROL TRAPS AFTER VEGETATION IS ESTABLISHED.

NOTE:

1. ALL DEMOLITION WORK TO BE CARRIED OUT IN ACCORDANCE WITH AS 2601-2001 (THE DEMOLITION OF STRUCTURES)

2. THIS DEMOLITION DRAWING GIVES AN INDICATION OF THE SCOPE REQUIRED TO CARRY OUT THE ALTERATIONS & ADDITIONS AS PROPOSED. THE BUILDER IS ASSUMED TO HAVE INSPECTED THE SITE DURING TENDERING & ALLOWED FOR ALL DEMOLITION INCLUDING SUNDRY WORKS NOT INDICATED ON THIS DRAWING THAT ARE REQUIRED IN ORDER TO CONSTRUCT THE WORKS.

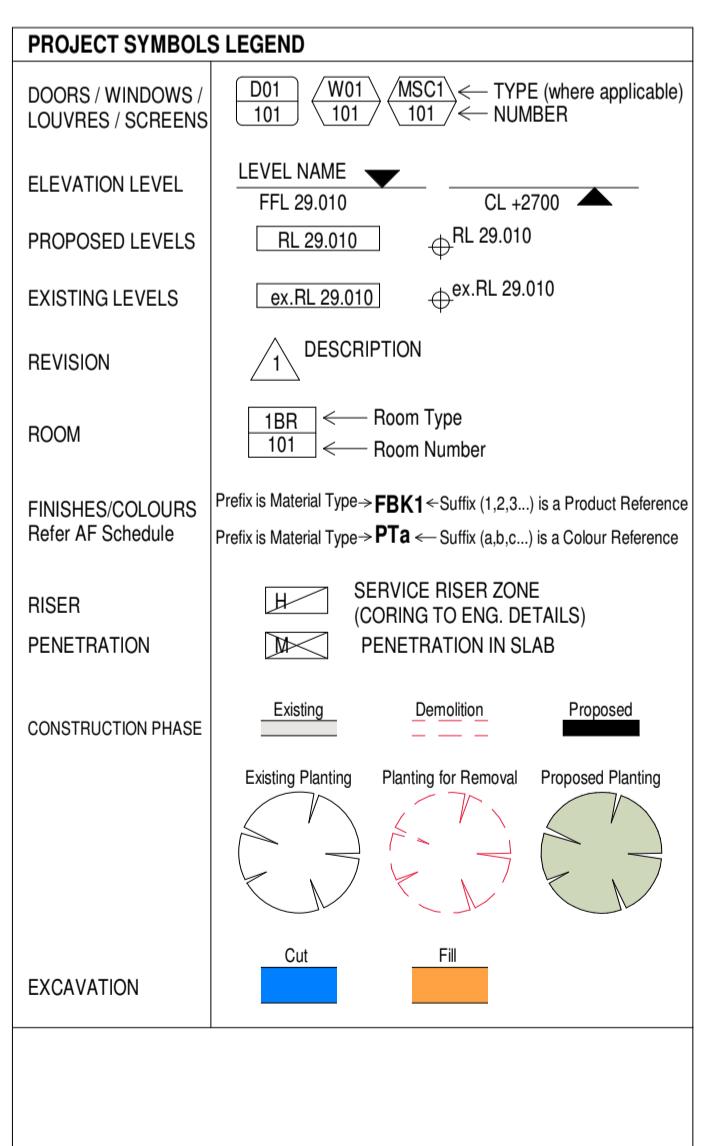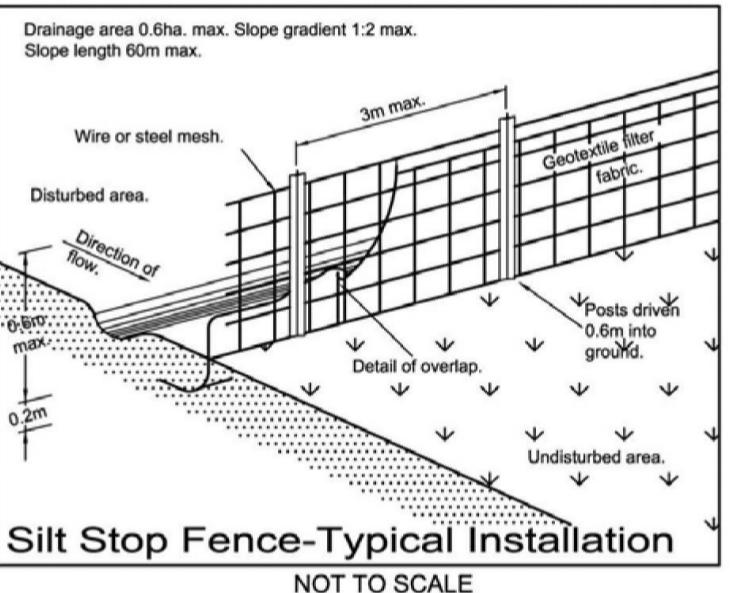

| ISSUE | DATE | AMENDMENT |
|-------|------------|-----------|
| A | 2024-08-30 | DA ISSUE |

DEMOLITION NOTE:
This demolition drawing gives an indication of the scope required to carry out the alterations & additions as proposed. The builder is assumed to have inspected the site during tendering & allowed for all demolition including sundry works not indicated on this drawing that are required in order to construct the works.



TRUE
NORTH

0 5 10 15 20m
(1:400@A3)

SCALE 1:200@A1

PROJECT PANANIA - LAHC 2021/505
CLIENT NSW LAHC
ADDRESS 171 Weston St & 2-6 Hinemoa St, Panania, NSW, 2213
LOT 42, 43, 44, 45 / DP35211
PHONE 1800 738 718

LOCKED BAG 5022
PARRAMATTA NSW 2124
ACN 159 480 056, ABN 41 159 480 056
(02) 9380 4946
PO Box 170, Potts Point, NSW 1135

PROJECT No. 21042
CLIENT LAHC
NOMINATED ARCHITECT - P.F.
MORSON GROUP
NSW GOVERNMENT

SHEET SIZE: A1 SHEET NAME: DEMOLITION PLAN
SCALE: 1:200

DRAWING No. DA10
ISSUE No. A



| ISSUE | DATE | AMENDMENT |
|-------|------------|----------------------------|
| A | 2024-08-30 | DA ISSUE |
| B | 2025-02-24 | DA MODS. |
| C | 2025-04-08 | Windows added as indicated |



| ISSUE | DATE | AMENDMENT |
|-------|------------|----------------------------|
| A | 2024-08-30 | DA ISSUE |
| B | 2025-02-24 | DA MODS. |
| C | 2025-04-08 | Windows added as indicated |

GENERAL LEGEND:

- BR Bedroom
- FFL Finished Floor Level
- RWO Rainwater Outlet
- LIN Linen Cupboard
- SWP Storm Water Pit
- BRM Broom Cupboard
- MBX Mailbox
- TOW Top of Wall
- CTI Clothesline
- PTY Pantry
- TGSi Tactile Indicators
- DW Dishwasher
- RL Relative Level
- ex. Existing



0

1

2

3

4

5

6

7

10m

(1:200@A3)

PROJECT
PANANIA - LAHC 2021/505
CLIENT
NSW LAHC
LOCKED BAG 5022
ADDRESS
171 Weston St & 2-6 Hinemoa St, Panania, NSW, 2213
PARRAMATTA NSW 2124
PHONE 1800 738 718

PROJECT No. 21042
CLIENT LAHC
NSW GOVERNMENT

NOMINATED ARCHITECT - P.F.
MORSON REGISTRATION NUMBER 8100
ACN 159 480 056, ABN 41 159 480 056
(02) 9380 4946
PO Box 170, Potts Point, NSW 1133

sheet size: A1 **sheet name:** LEVEL 1 PLAN
scale: As indicated

DRAWING No. DA13
issue no. C



| ISSUE | DATE | AMENDMENT |
|-------|------------|----------------------------|
| A | 2024-08-30 | DA ISSUE |
| B | 2025-02-24 | DA MODS. |
| C | 2025-04-08 | Windows added as indicated |



| ISSUE | DATE | AMENDMENT |
|-------|------------|-----------|
| A | 2024-08-30 | DA ISSUE |
| B | 2025-02-24 | DA MODS. |



0
1
2
3
4
5
7
10m
(1:200@A1)

SCALE 1:100@A1

0
1
2
3
4
5
7
10m
(1:200@A3)

SCALE 1:200@A3

PROJECT
PANANIA - LAHC 2021/505
CLIENT
NSW LAHC
ADDRESS
171 Weston St & 2-6 Hinemoa St, Panania, NSW, 2213
PARRAMATTA NSW 2124
LOT 42, 43, 44, 45 / DP35211
PHONE 1800 738 718

PROJECT No.
21042
CLIENT
LAHC
NOMINATED ARCHITECT - P.F.
MORSON REGISTRATION NUMBER 8103
ACN 159 480 056, ABN A159 480 056
(02) 9380 4946
PO Box 170, Potts Point, NSW 1135

MORSON
GROUP

x

21042

21042

SHEET
NAME: BASEMENT PLAN
SCALE:
1:100

DRAWING No.
DA11
ISSUE No.
B



| ISSUE | DATE | AMENDMENT | GENERAL LEGEND: | TRUE NORTH | SCALE 1:100@A1 (1:200@A3) | PROJECT | CLIENT | PROJECT No. | DRAWING No. |
|-------|------------|-----------|-------------------------|--------------------------|---------------------------|--|-------------|-------------|-------------|
| A | 2024-08-30 | DA ISSUE | BR Bedroom | FFL Finished Floor Level | 0 1 2 3 4 5 7 | PANANIA - LAHC 2021/505 | NSW LAHC | 21042 | DA15 |
| B | 2025-02-24 | DA MODS. | BRM Broom Cupboard | RWO Rainwater Outlet | 10m | LOCKED BAG 5022 | CLIENT LAHC | | |
| | | | CTL Clothesline | LIN Linen Cupboard | | ADDRESS 171 Weston St & 2-6 Hinemoa St, Panania, NSW, 2213 PARRAMATTA NSW 2124 LOT 42, 43, 44, 45 / DP35211 PHONE 1800 738 718 | | | |
| | | | DW Dishwasher | MBX Mailbox | | | | | |
| | | | ex. Existing | PTY Pantry | | | | | |
| | | | RL Relative Level | TOW Top of Wall | | | | | |
| | | | TGSI Tactile Indicators | | | | | | |



| ISSUE | DATE | AMENDMENT |
|-------|------------|-----------|
| A | 2024-08-30 | DA ISSUE |
| B | 2025-02-24 | DA MODS. |

GENERAL LEGEND:

- BR Bedroom
- BRM Broom Cupboard
- CLO Clothesline
- DW Dishwasher ex. Existing
- FFL Finished Floor Level
- LIN Linen Cupboard
- MBX Mailbox
- PTY Pantry
- RL Relative Level
- RWO Rainwater Outlet
- SWP Storm Water Pit
- TOW Top of Wall
- TGSI Tactile Indicators



0

1

2

3

4

5

6

7

10m

(1:200@A3)

PROJECT PANANIA - LAHC 2021/505
CLIENT NSW LAHC
ADDRESS 171 Weston St & 2-6 Hinemoa St, Panania, NSW, 2213
LOT 42, 43, 44, 45 / DP35211

NSW GOVERNMENT

PROJECT No. 21042
CLIENT LAHC

MORSON GROUP

NOMINATED ARCHITECT - P.F. MORSON REGISTRATION NUMBER 8100
ACN 159 480 056, ABN 41 159 480 056
(02) 9380 4946
PO Box 170, Potts Point, NSW 1135

SHEET SIZE: A1

SHEET NAME: ROOF LEVEL PLAN
SCALE: 1:100



| ISSUE | DATE | AMENDMENT | ELEVATIONS & SECTIONS LEGEND: | NOTES: | CLIENT | PROJECT No. | PROJECT No. | SHEET SIZE: A1 | SHEET NAME: ELEVATIONS - SHEET 1 | DRAWING No. DA17 |
|-------|------------|-----------|--|---|---|-------------|--------------|--|----------------------------------|------------------|
| A | 2024-08-30 | DA ISSUE | RL Relative Level TOH Top of Hob TOW Top of Wall | 1. Read in conjunction with Window Schedule for glass types & frame finishes. | NSW LAHC LOCKED BAG 5022 171 Weston St & 2-6 Hinemoa St, Panania, NSW, 2213 LOT 42, 43, 44, 45 / DP35211 | 21042 | MORSON GROUP | NOMINATED ARCHITECT - P.F. MORSON REGISTRATION NUMBER 8103 ACN 159 480 054, ABN 41 159 480 054 (02) 9380 4946 PO Box 170, Potts Point, NSW 1133 | As indicated | ISSUE No. B |
| B | 2025-02-24 | DA MODS. | | | SCALE 1:100@A1 | 1:200@A3 | | | | |

| THERMAL PERFORMANCE SPECIFICATIONS | |
|---|--|
| WINDOWS (total product specification – glass + frame) | |
| 6.38COP glass in AL frames | |
| EXTERNAL WALL (Medium colour) | |
| Brick Veneer – R2.0 bulk insulation with antiglare reflective airgap | |
| INTERNAL WALL | |
| Concrete / Brick Partition walls (no thermal insulation required) | |
| EXTERNAL FLOOR | |
| Slab on ground concrete – No insulation required | |
| Suspended concrete (Basement below) – R1.5 bulk insulation | |
| Suspended Concrete (Neighboor below) – No insulation | |
| Ceiling with CONCRETE ROOF deck | |
| Perforated – R2.0 bulk insulation; 900mm dia ceiling fans in all bedrooms | |
| ROOF (Medium colour) (Non-ventilated) | |
| CONCRETE – vapour barrier only | |
| RATED either with NO DOWNLIGHTS or with LED downlights which do not generate ceiling insulation (ie: IC rated) | |
| 900mm dia ceiling fans in all bedrooms; 1200mm dia fan in Living/kitchen areas | |
| This specification takes precedence over other plan notations. | |
| NOTE: In addition to these components, building compliance is required to comply with the New South Wales Additions in the current edition of the NCC, at the time of building. | |
| This includes New South Wales: | |
| • Building Thermal construction | |
| • External walls, thermal breaks | |
| • Floor edges | |
| • Sealing of roughights, windows and doors 3 | |
| • Any new heating ventilation system | |
| • Any new heated water system | |
| • Energy monitoring equipment | |
| Refer to current HERS Certificate to validate these thermal specification details. | |



| ISSUE | DATE | AMENDMENT | ELEVATIONS & SECTIONS LEGEND: | NOTES: | PROJECT | CLIENT | PROJECT No. | DRAWING No. |
|-------|------------|-----------|--|--|--|---|-------------------------------------|--------------|
| A | 2024-08-30 | DA ISSUE | RL Relative Level TOH Top of Hob TOW Top of Wall | 1. Read in conjunction with Window Schedule for glass types & frame finishes. | PANANIA - LAHC 2021/505 | NSW LAHC LOCKED BAG 5022 171 Weston St & 2-6 Hinemoa St, Panania, NSW, 2213 LOT 42, 43, 44, 45 / DP35211 | 21042 | MORSON GROUP |
| B | 2025-02-24 | DA MODS. | | | | | | |
| | | | | | CLIENT NSW GOVERNMENT | PROJECT No. 21042 | SHEET NAME: ELEVATIONS - SHEET 2 | DA18 |
| | | | | | NOTIFIED ARCHITECT - P F MORSON REGISTRATION NUMBER 8100 ACN 159 480 056, ABN A159 480 056 PHONE 1800 738 718 (02) 9380 4946 PO Box 170, Potts Point, NSW 1135 | SCALE: As indicated | ISSUE No. B | |

Thermal Performance Specifications

WINDOWS (total product specification – glass + frame)
6.38COP/glass in AL frames

EXTERNAL WALL (Medium colour)
Brick Veneer – R2.0 bulk insulation with anti-glare reflective airgap

INTERNAL WALL
Concrete Partition walls (no thermal insulation required)

EXTERNAL FLOOR
Slab on ground concrete – No insulation required

Suspended concrete (Basement below) – R1.5 bulk insulation

Suspended Concrete (Neighbr. below) – No insulation

Ceilings with CONCRETE ROOF deck
Perforated – R2.0 bulk insulation; 900mm dia ceiling fans in all bedrooms

ROOF (Medium colour) (Non-ventilated)
CONCRETE – vapour barrier only






RATED either with NO DOWNLIGHTS or with LED downlights which do not penetrate ceiling insulation (ie: IC rated)
900mm dia ceiling fans in all bedrooms; 1200mm dia fan in Living/kitchen areas

This specification takes precedence over other plan notations.

NOTE: In addition to compliance, building compliance is required to comply with the New South Wales Building Act in the current edition of the NCC, at the time of building. This includes New South Wales:

- Building Thermal construction
- Fire resistance, thermal breaks
- Sealing of rooflights, windows and doors 3
- Any new heating, ventilation and air conditioning system
- Any new heated water system
- Energy monitoring equipment


Refer to current HERS Certificate to validate these thermal specification details.

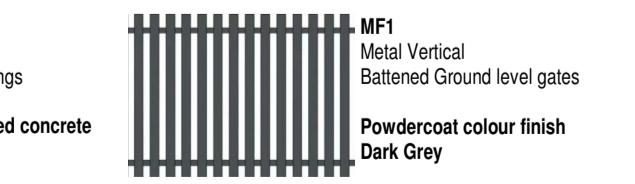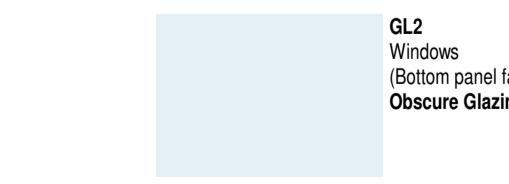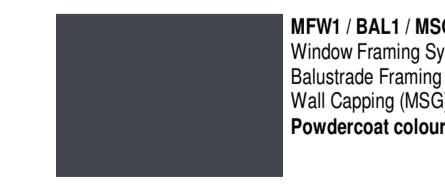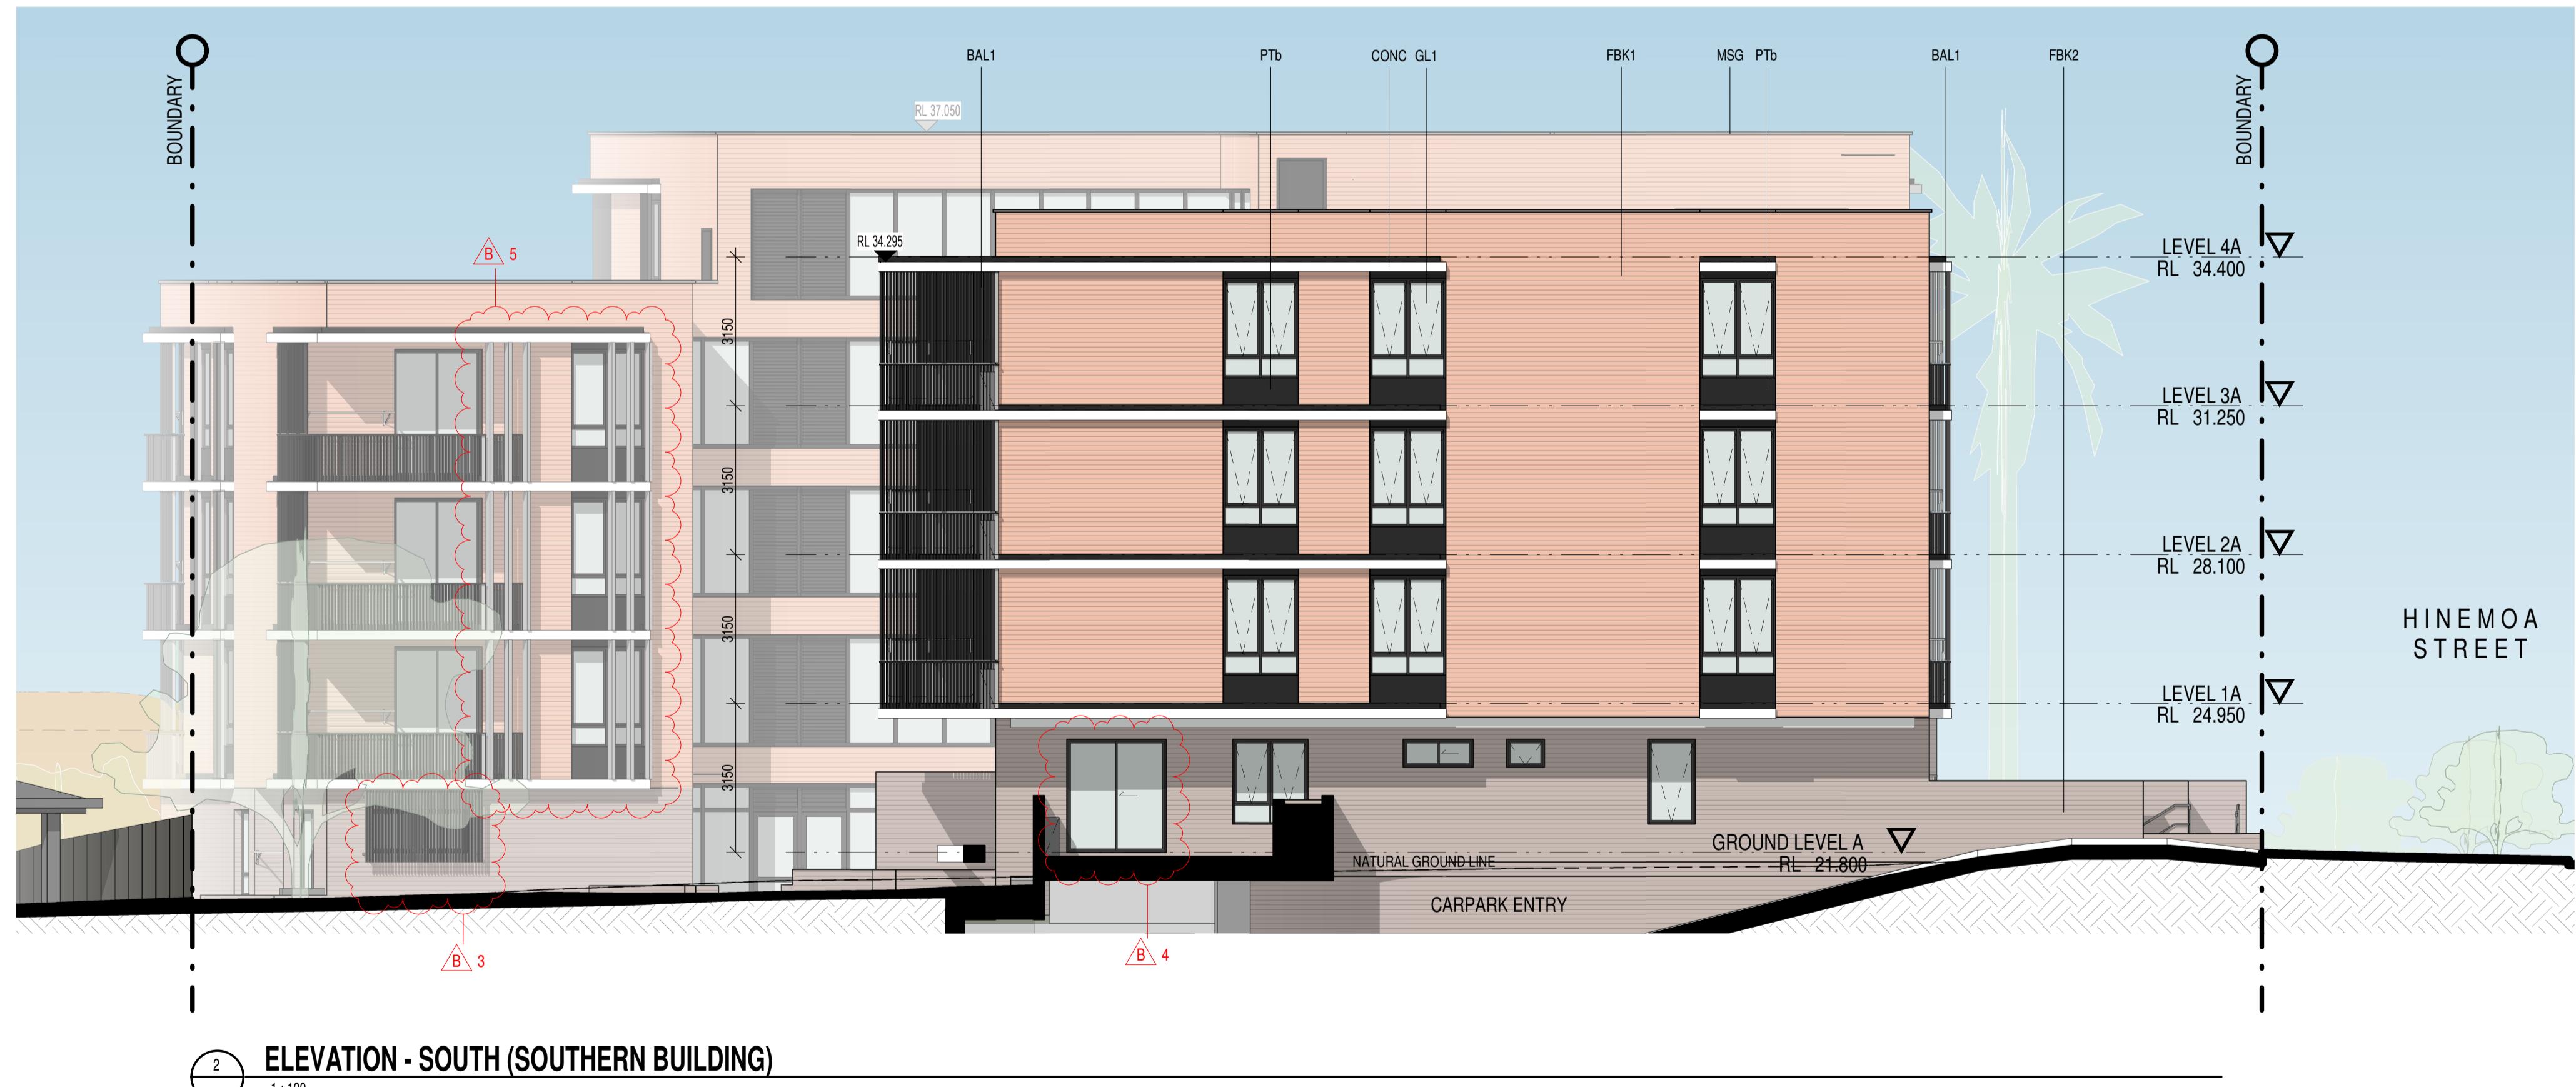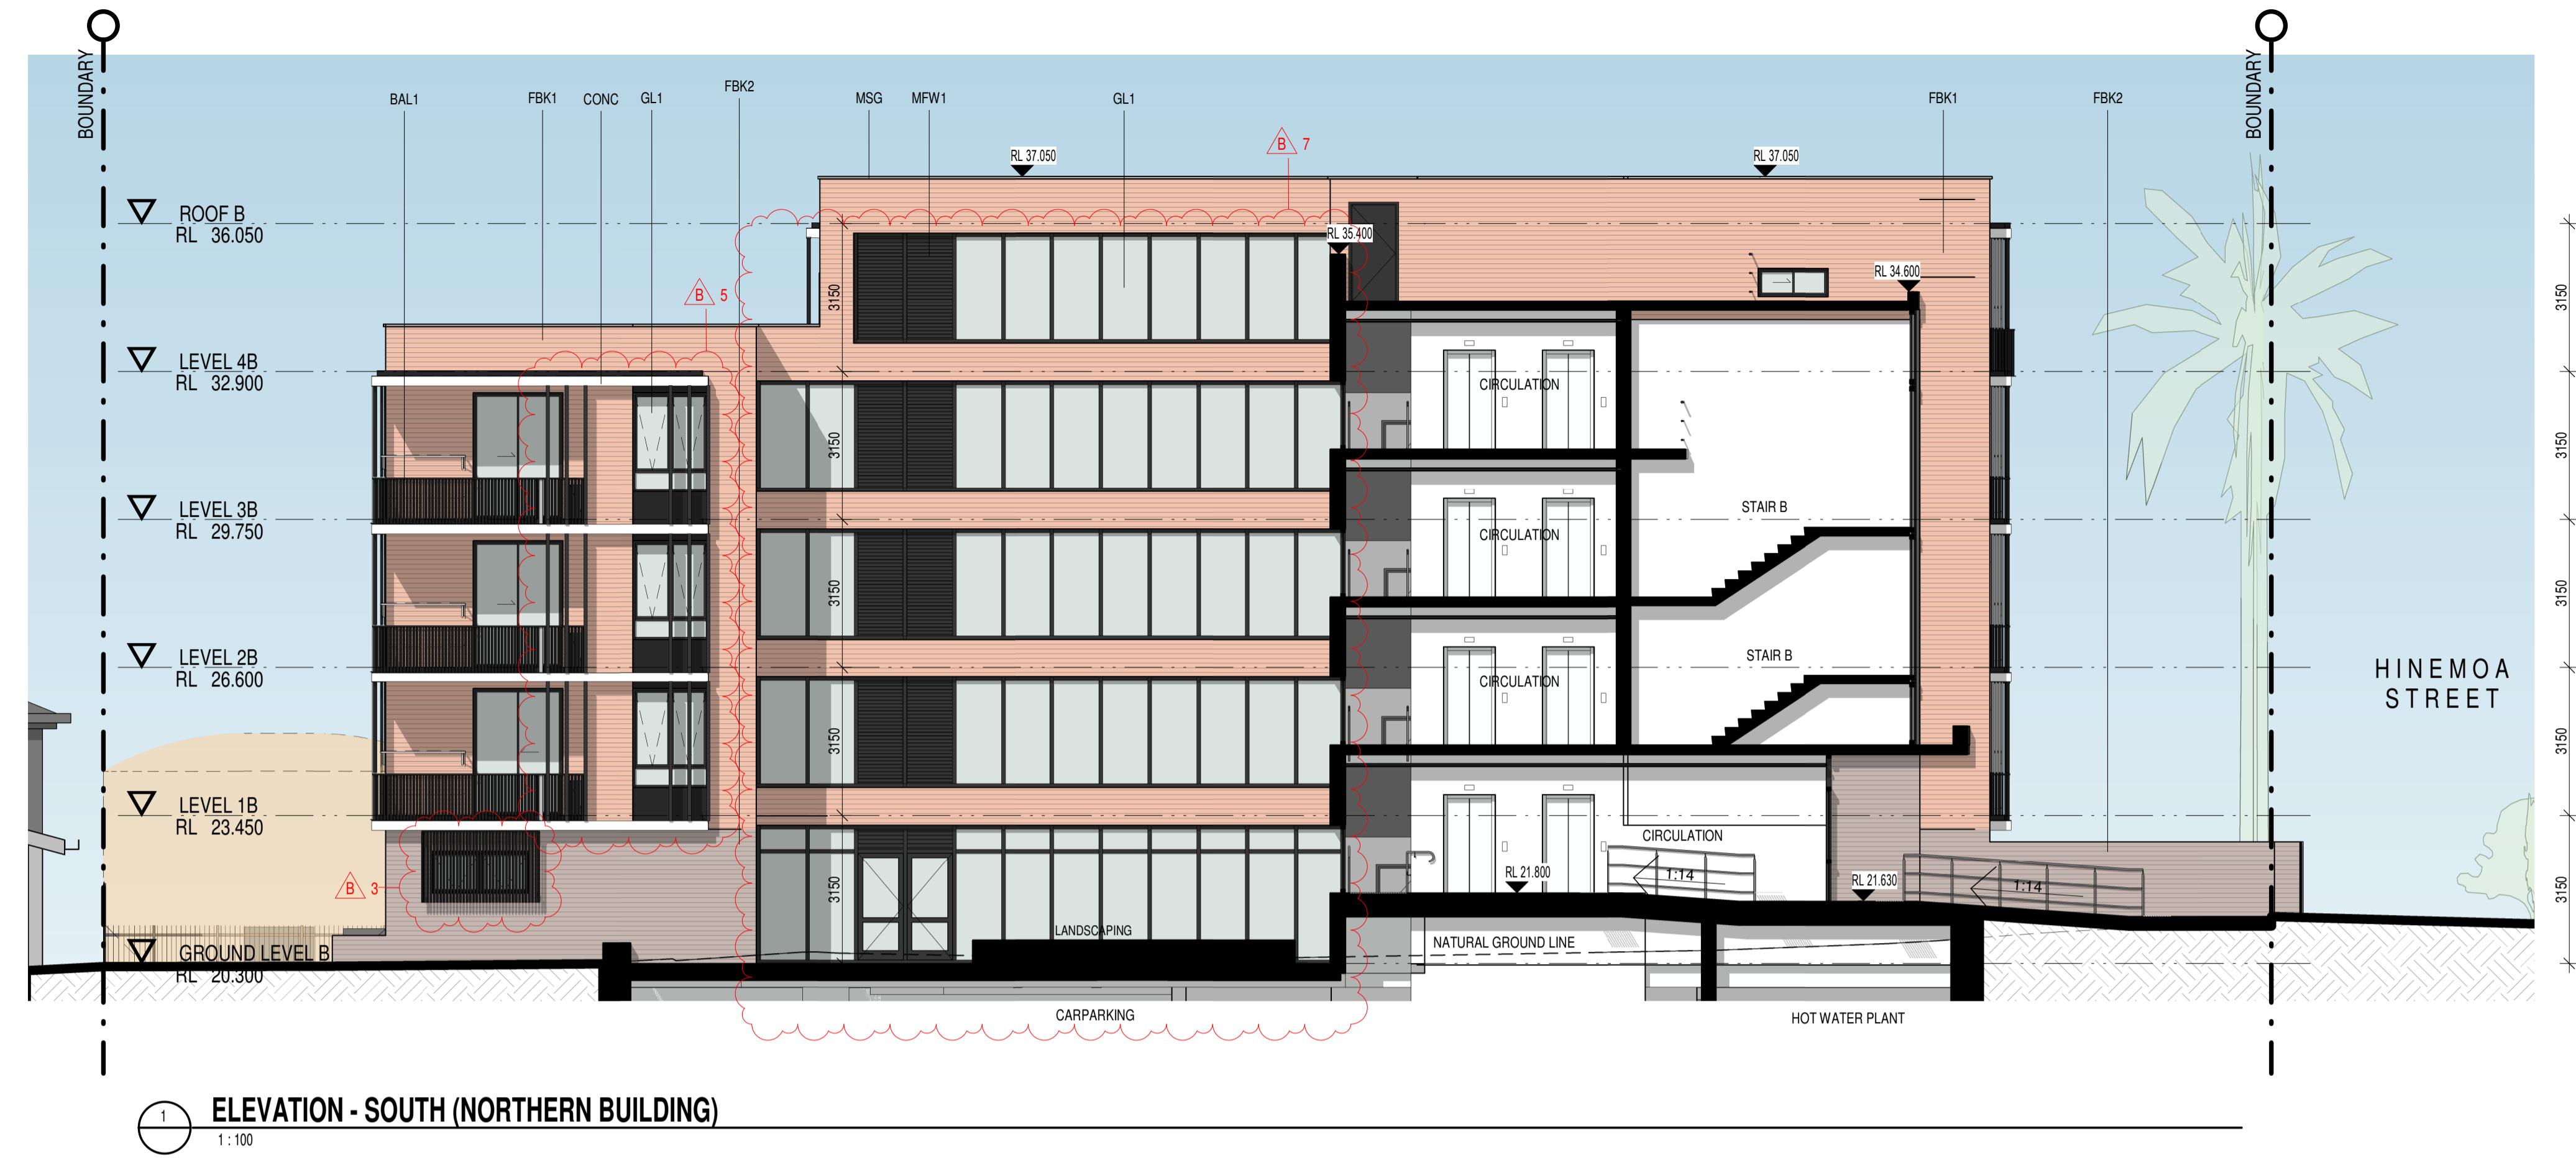

| ISSUE | DATE | AMENDMENT |
|-------|------------|-----------|
| A | 2024-08-30 | DA ISSUE |
| B | 2025-02-24 | DA MODS. |

ELEVATIONS & SECTIONS LEGEND:
RL Relative Level
TOH Top of Hob
TOW Top of Wall

NOTES:
1. Read in conjunction with Window Schedule
for glass types & frame finishes.

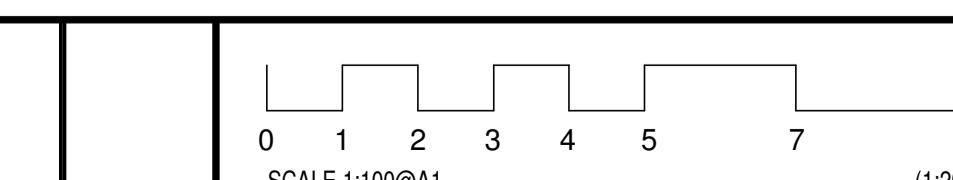

PROJECT PANANIA - LAHC 2021/505
CLIENT NSW LAHC
ADDRESS 171 Weston St & 2-6 Hinemoa St, Panania, NSW, 2213
LOT 42, 43, 44, 45 / DP35211
PHONE 1800 738 718

PROJECT No. 21042
CLIENT LAHC
NSW GOVERNMENT

NOMINATED ARCHITECT - P.F.
MORSON GROUP PTY LTD
ACN 159 480 056, ABN A159 480 056
(02) 9380 4946
PO Box 170, Pootts Point, NSW 1335



MORSON
GROUP

SHEET NAME: ELEVATIONS - SHEET 3
SCALE: As indicated


DRAWING No. DA19
ISSUE No. B



| ISSUE | DATE | AMENDMENT | ELEVATIONS & SECTIONS LEGEND: | NOTES: | CLIENT | PROJECT No. | DRAWING No. |
|-------|------------|-----------|--|---|--|---|-------------|
| A | 2024-08-30 | DA ISSUE | RL Relative Level TOH Top of Hob TOW Top of Wall | 1. Read in conjunction with Window Schedule for glass types & frame finishes. | NSW LAHC LOCKED BAG 5022 171 Weston St & 2-6 Hinemoa St, Panania, NSW, 2213 PARRAMATTA NSW 2124 LOT 42, 43, 44, 45 / DP35211 | 21042 MORSON GROUP NOMINATED ARCHITECT - P F MORSON REGISTRATION NUMBER 8100 ACN 159 480 056, ABN A1 159 480 056 (02) 9380 4946 PO Box 170, Potts Point, NSW 1135 | DA20 A |
| | | | SCALE 1:100@A1 | 0 1 2 3 4 5 7 10m (1:200@A3) | SHEET NAME: SECTIONS - SHEET 1 | SCALE: 1:100 | ISSUE No. |

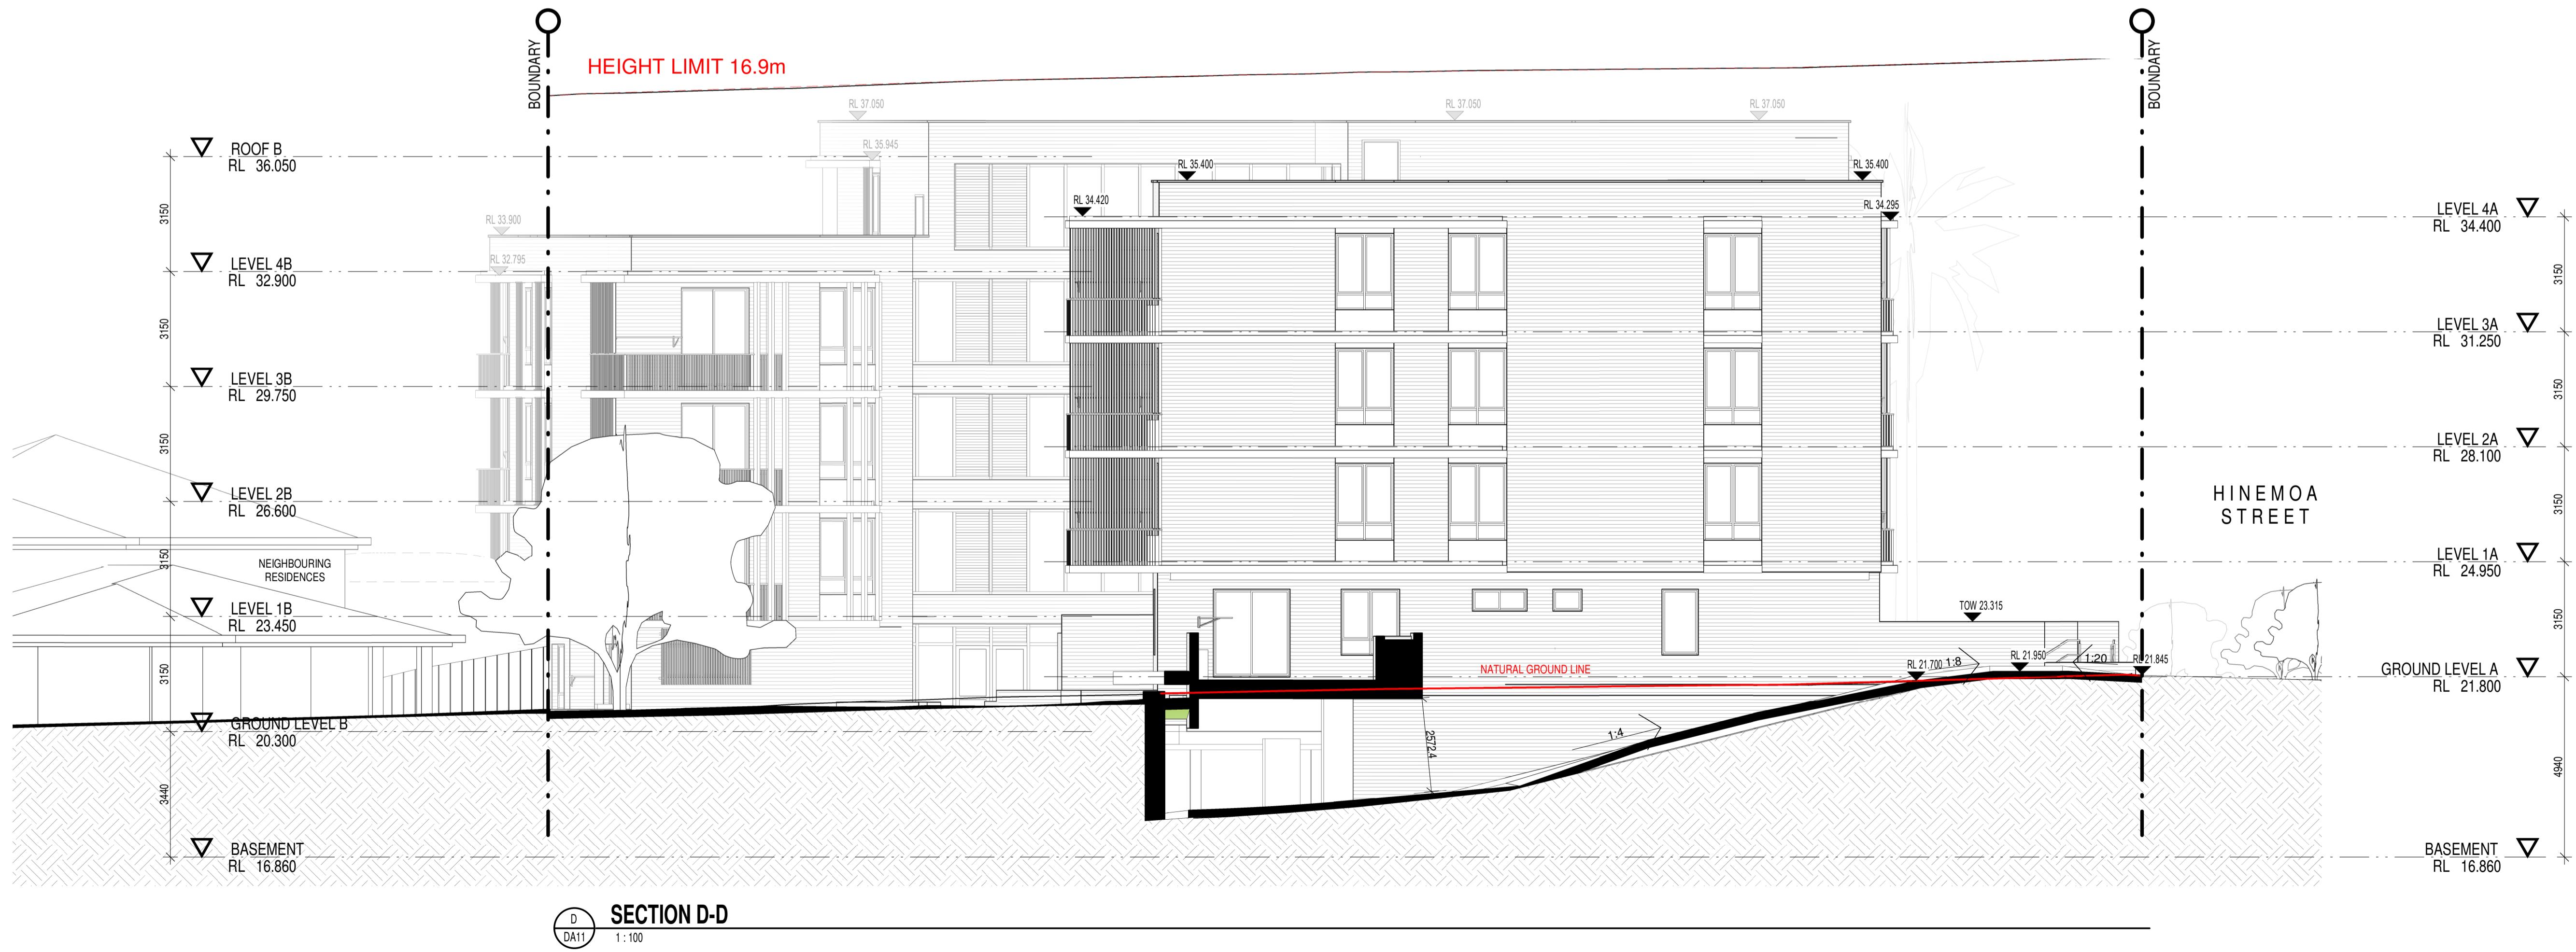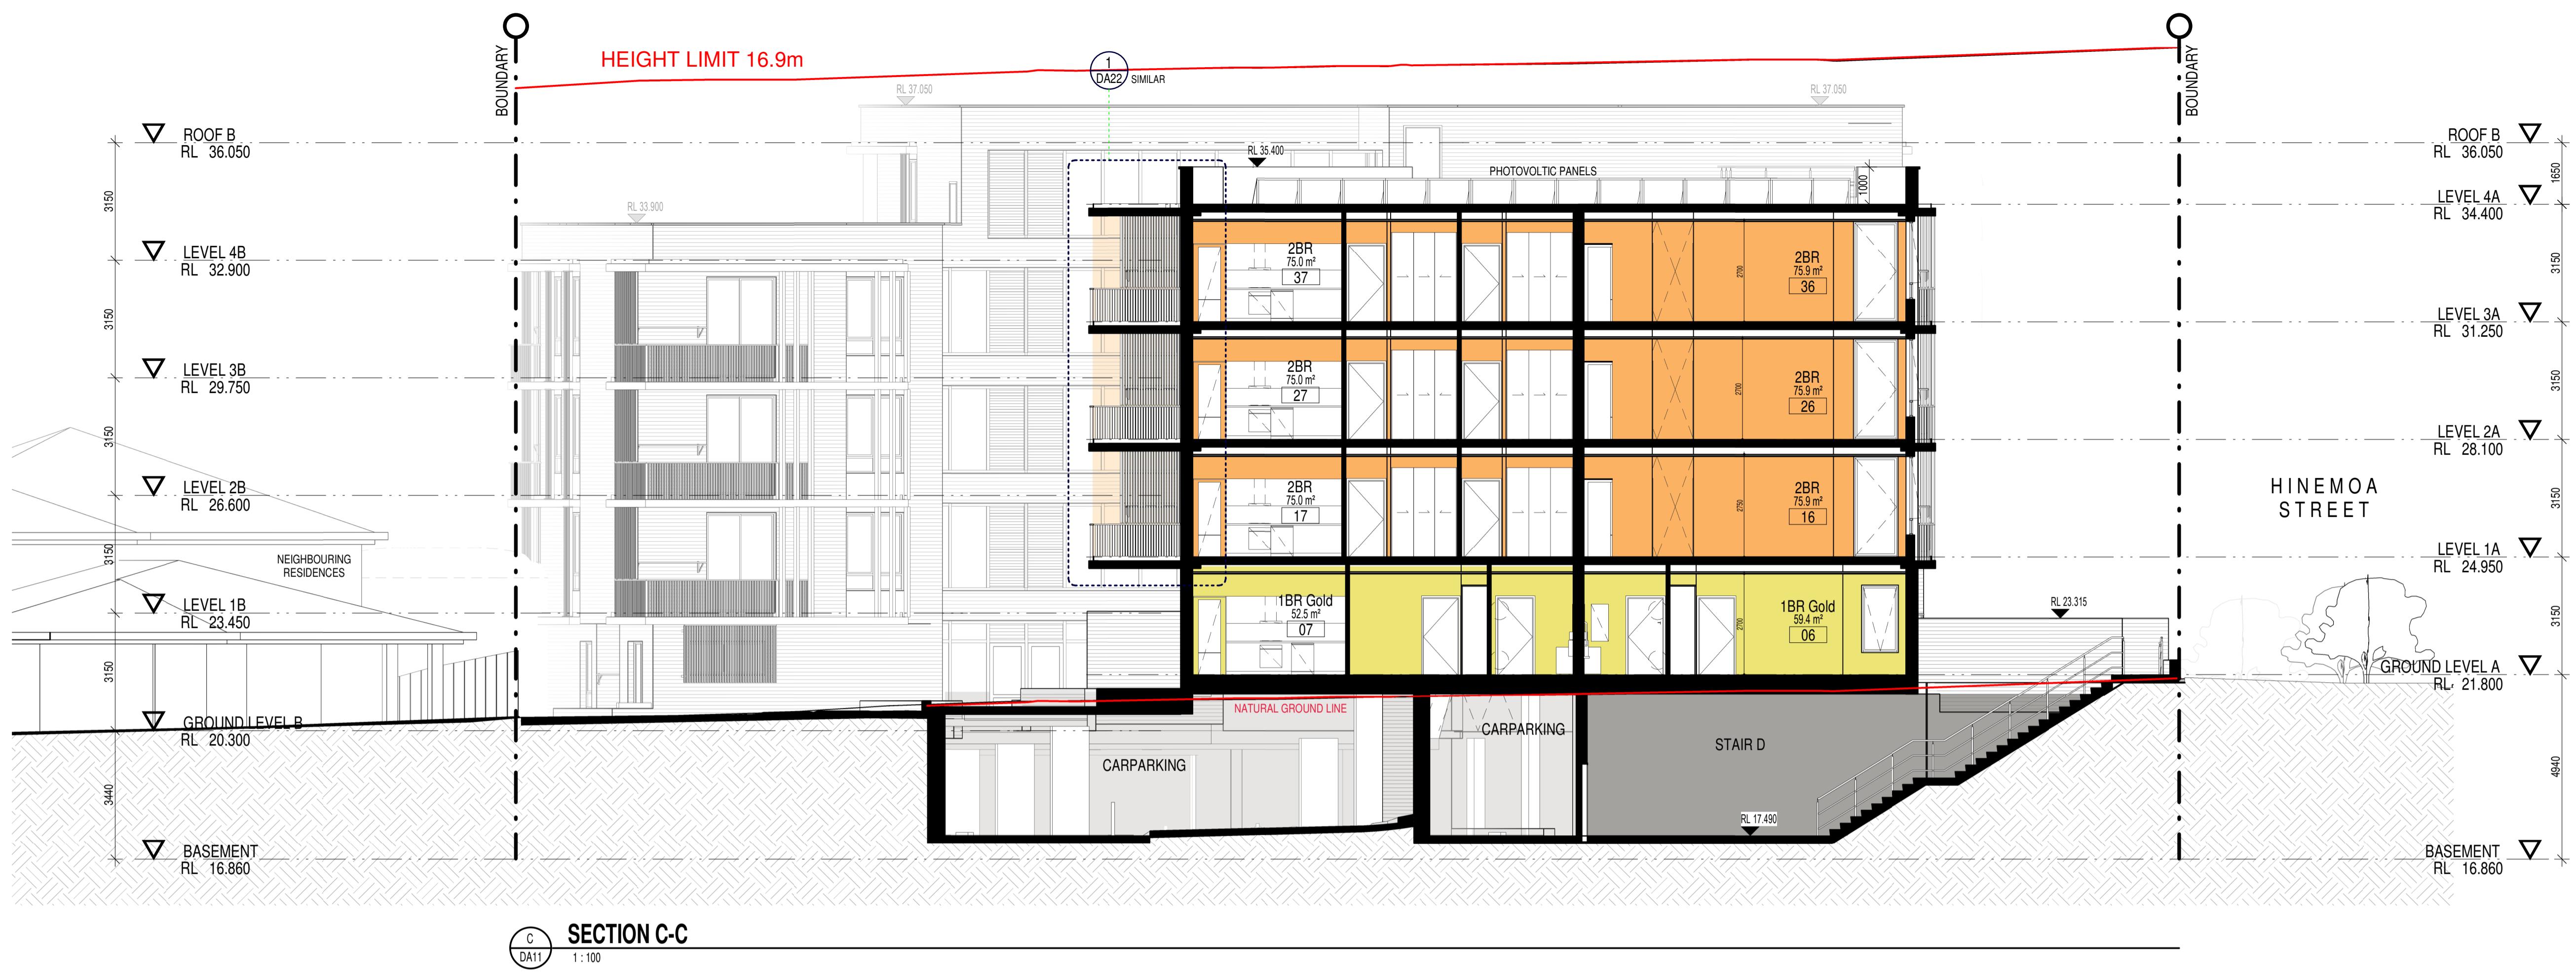


| ISSUE | DATE | AMENDMENT | ELEVATIONS & SECTIONS LEGEND: | NOTES: | CLIENT | PROJECT No. | DRAWING No. | |
|-------|------------|-----------|--|--|--|---|-----------------------|------------------------|
| A | 2024-08-30 | DA ISSUE | RL Relative Level TOH Top of Hob TOW Top of Wall | 1. Read in conjunction with Window Schedule for glass types & frame finishes. | PANANIA - LAHC 2021/505 ADDRESS 171 Weston St & 2-6 Hinemoa St, Panania, NSW, 2213 PARRAMATTA NSW 2124 LOT 42, 43, 44, 45 / DP35211 PHONE 1800 738 718 | NSW GOVERNMENT LOCKED BAG 5022 CLIENT LAHC | 21042 MORSON GROUP | DA21 ISSUE No. A |
| | | | SCALE 1:100@A1 | 0 1 2 3 4 5 6 7 10m (1:200@A3) | NOMINATED ARCHITECT - P F MORSON REGISTRATION NUMBER 8100 ACN 159 480 056, ABN A159 480 056 171 Weston Street, Parramatta NSW 2124 (02) 9380 4946 PO Box 170, Parramatta NSW 1335 | SHEET SIZE: A1 NAME: SECTIONS - SHEET 2 SCALE: 1:100 | | |

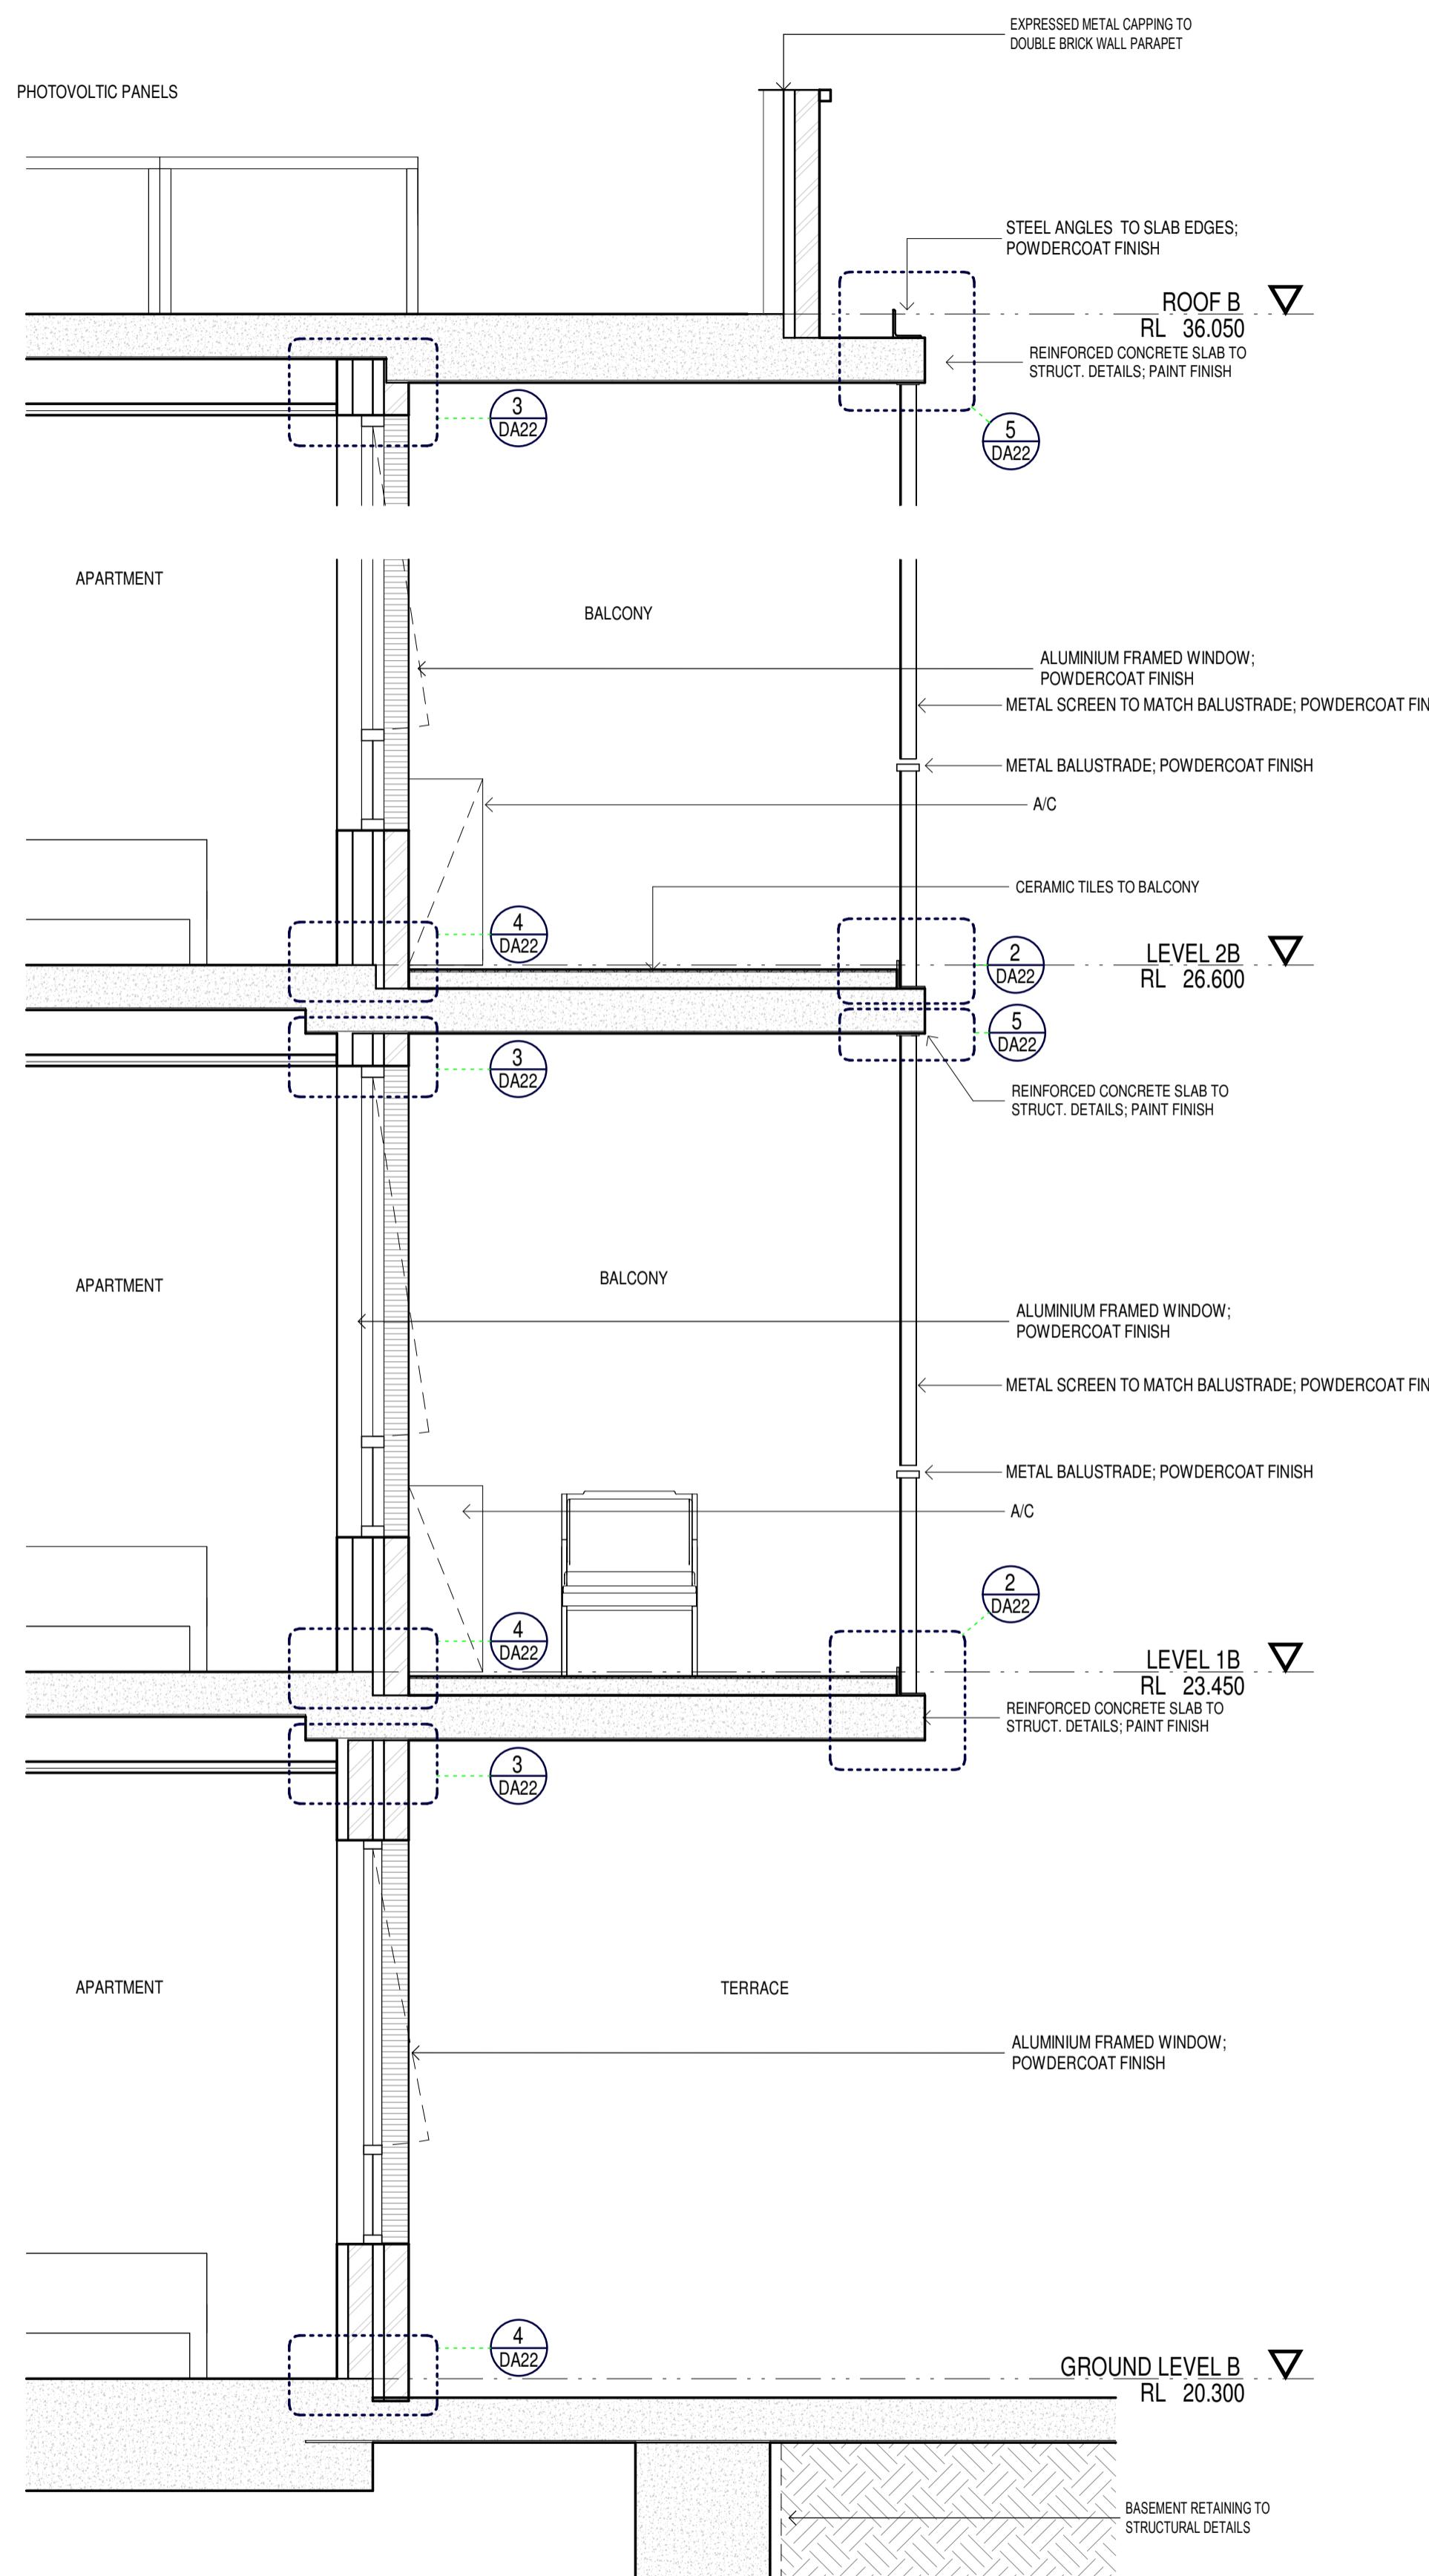

FACADE SECTION 1

DA12 1:25

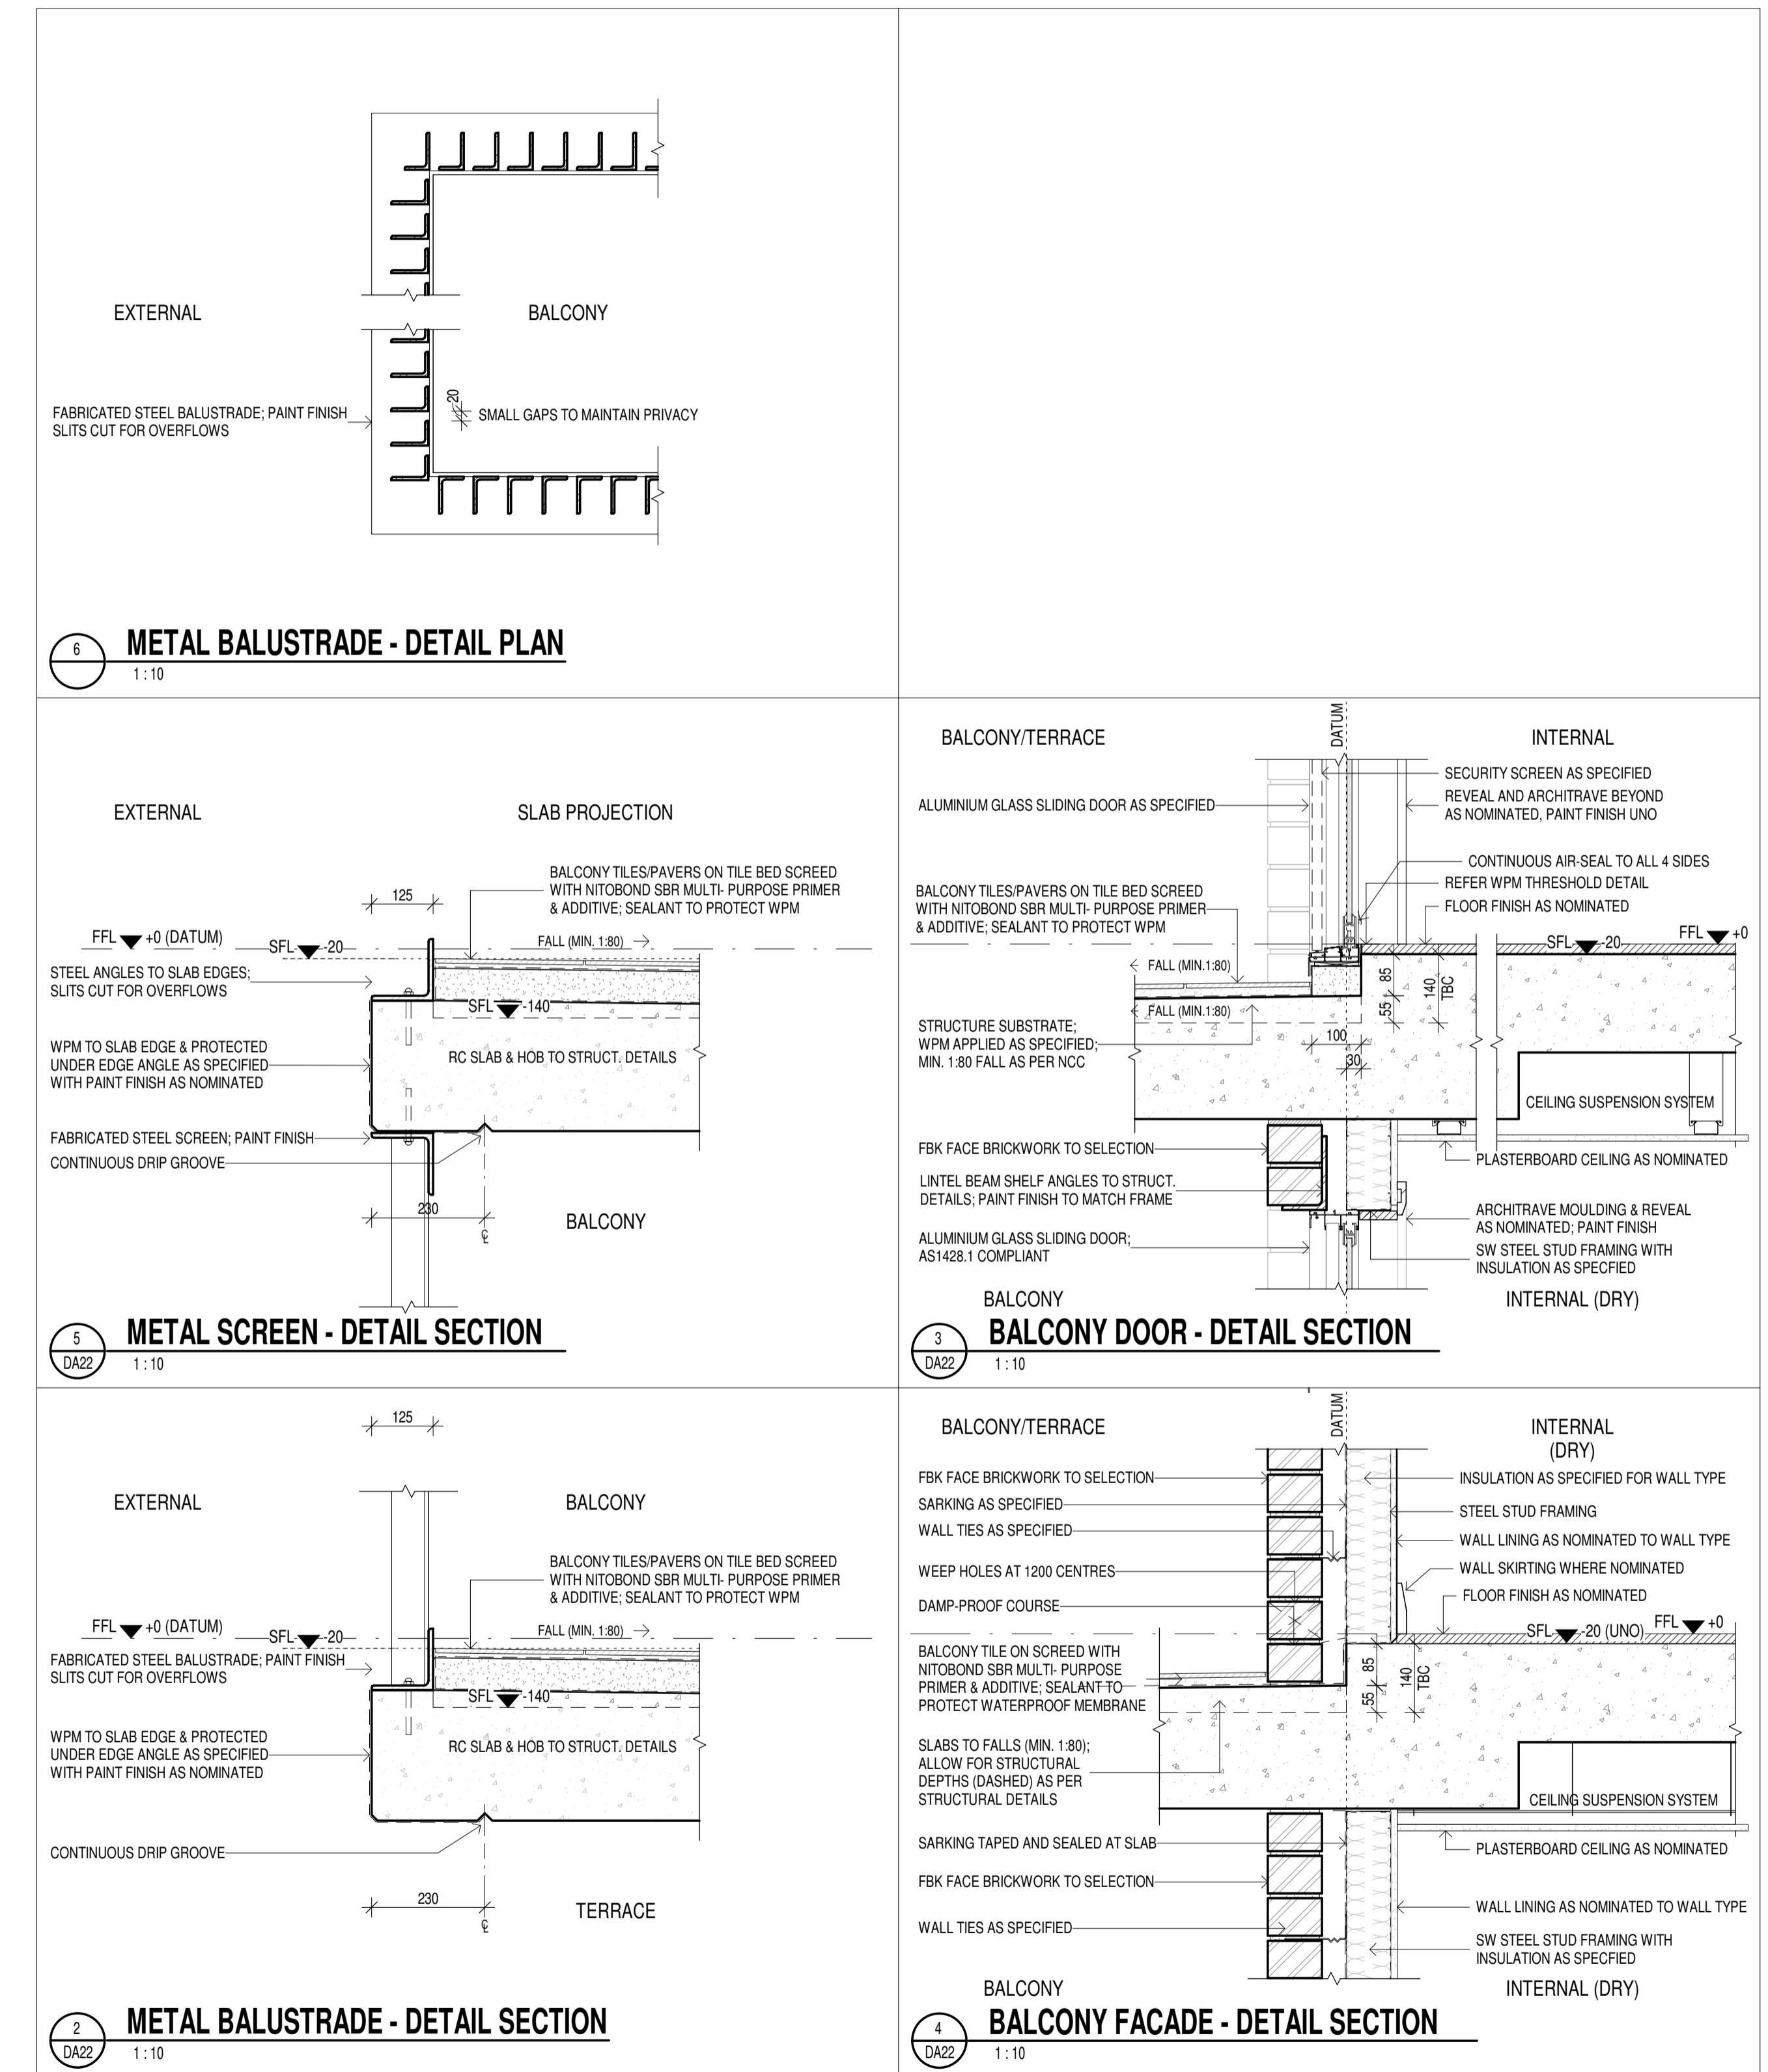

| ISSUE | DATE | AMENDMENT |
|-------|------------|-----------|
| A | 2024-08-30 | DA ISSUE |
| | | |

ELEVATIONS & SECTIONS LEGEND:
RL Relative Level
TOH Top of Hob
TOW Top of Wall

NOTES:
1. Read in conjunction with Window Schedule
for glass types & frame finishes.

PROJECT
PANANIA - LAHC 2021/505
CLIENT
NSW LAHC
ADDRESS
171 Weston St & 2-6 Hinemoa St, Panania, NSW, 2213
LOT 42, 43, 44, 45 / DP35211
PHONE 1800 738 718


PROJECT No.
21042
CLIENT
LAHC
NSW GOVERNMENT

NOMINATED ARCHITECT - P F
MORSON REGISTRATION NUMBER 8100
ACN 159 480 056, ABN A159 480 056
(02) 9380 4946
PO Box 170, Potts Point, NSW 1133

MORSON GROUP

SHEET SIZE: A1 NAME: **FAÇADE DETAILS**
SCALE: As indicated


DRAWING No.: **DA22**
ISSUE No.: **A**

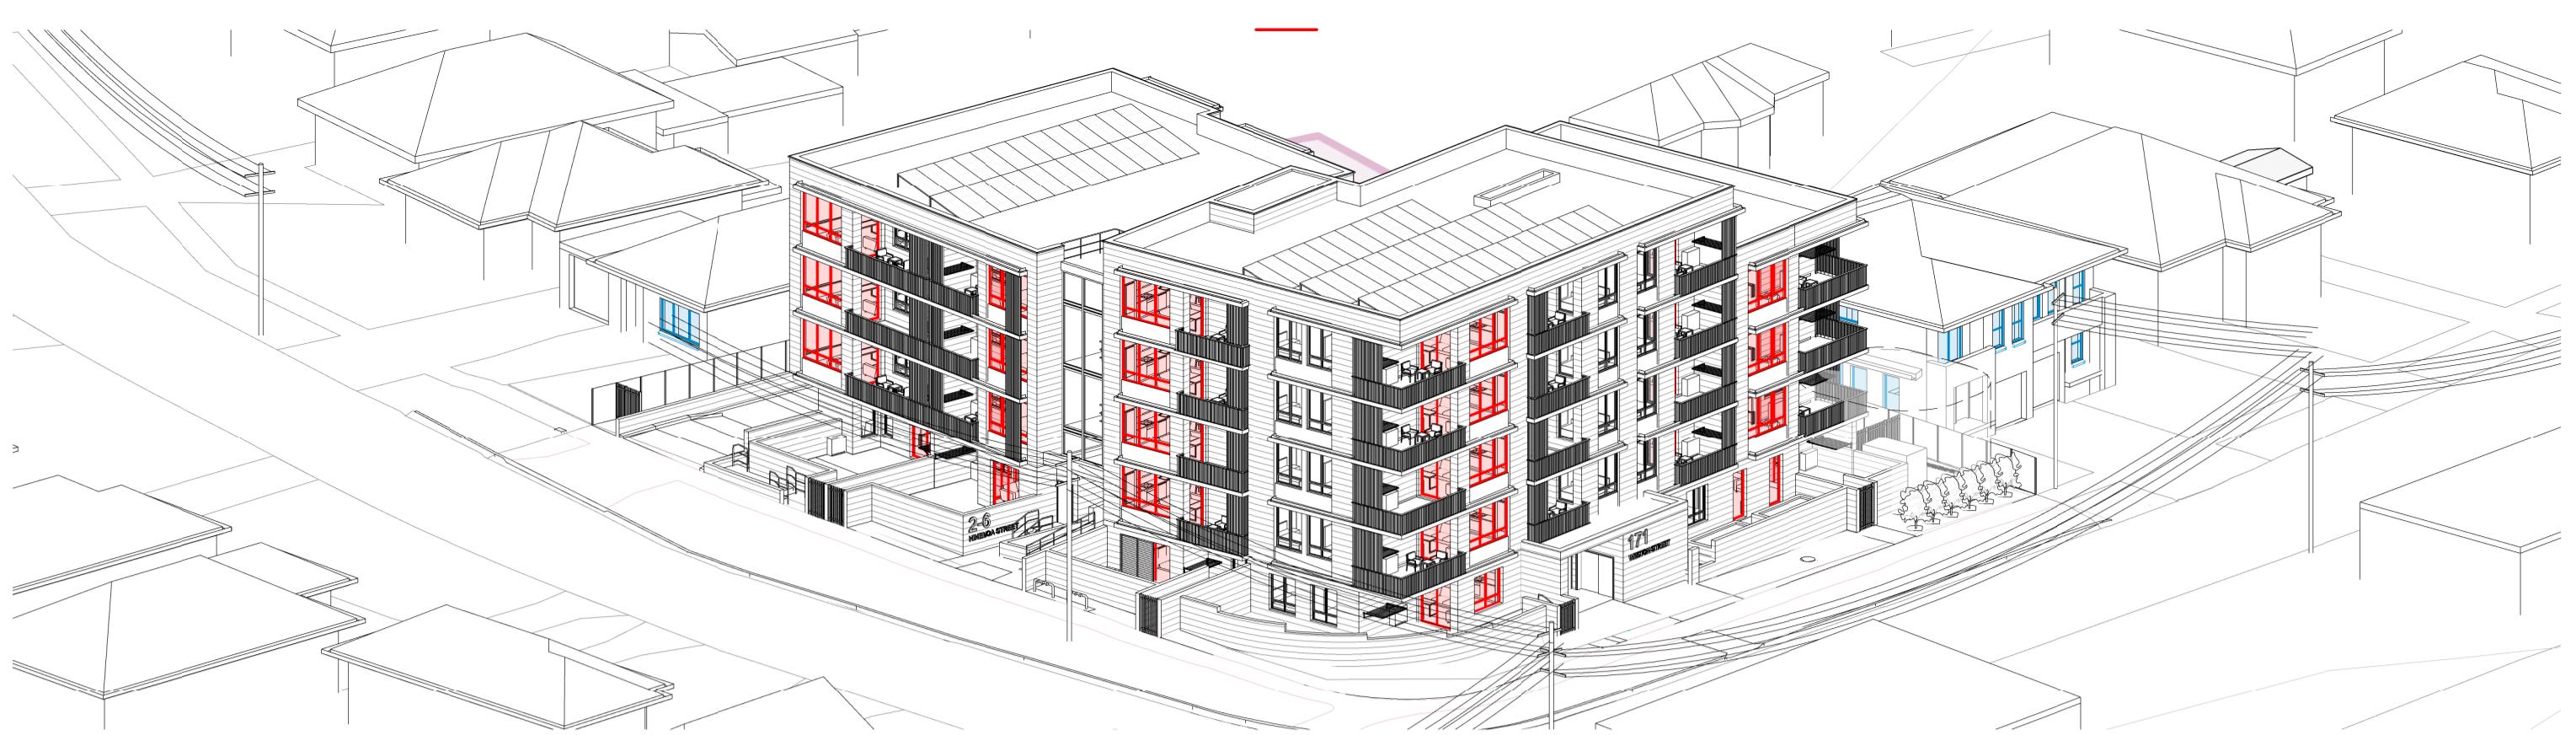


9AM EYE FROM THE SUN - 9.00AM JUN




9:30 EYE FROM THE SUN - 9.30AM JUN

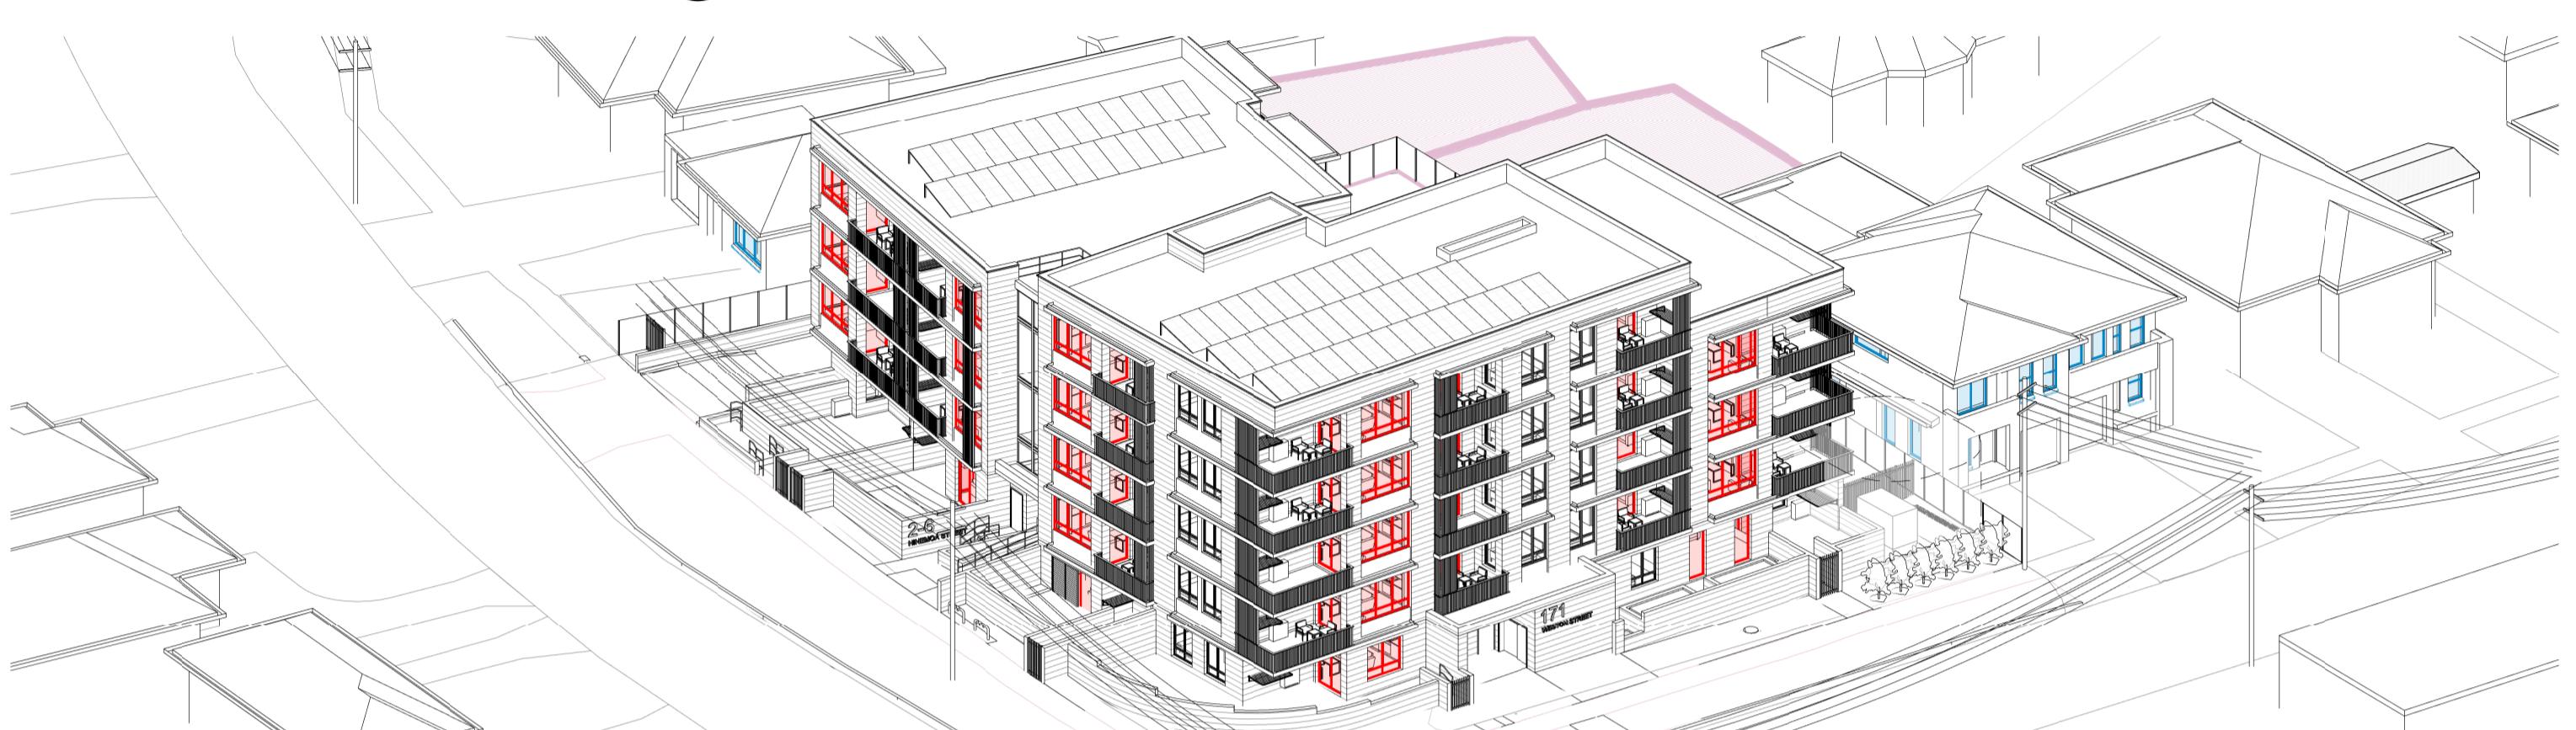

10AM EYE FROM THE SUN - 10AM JUN

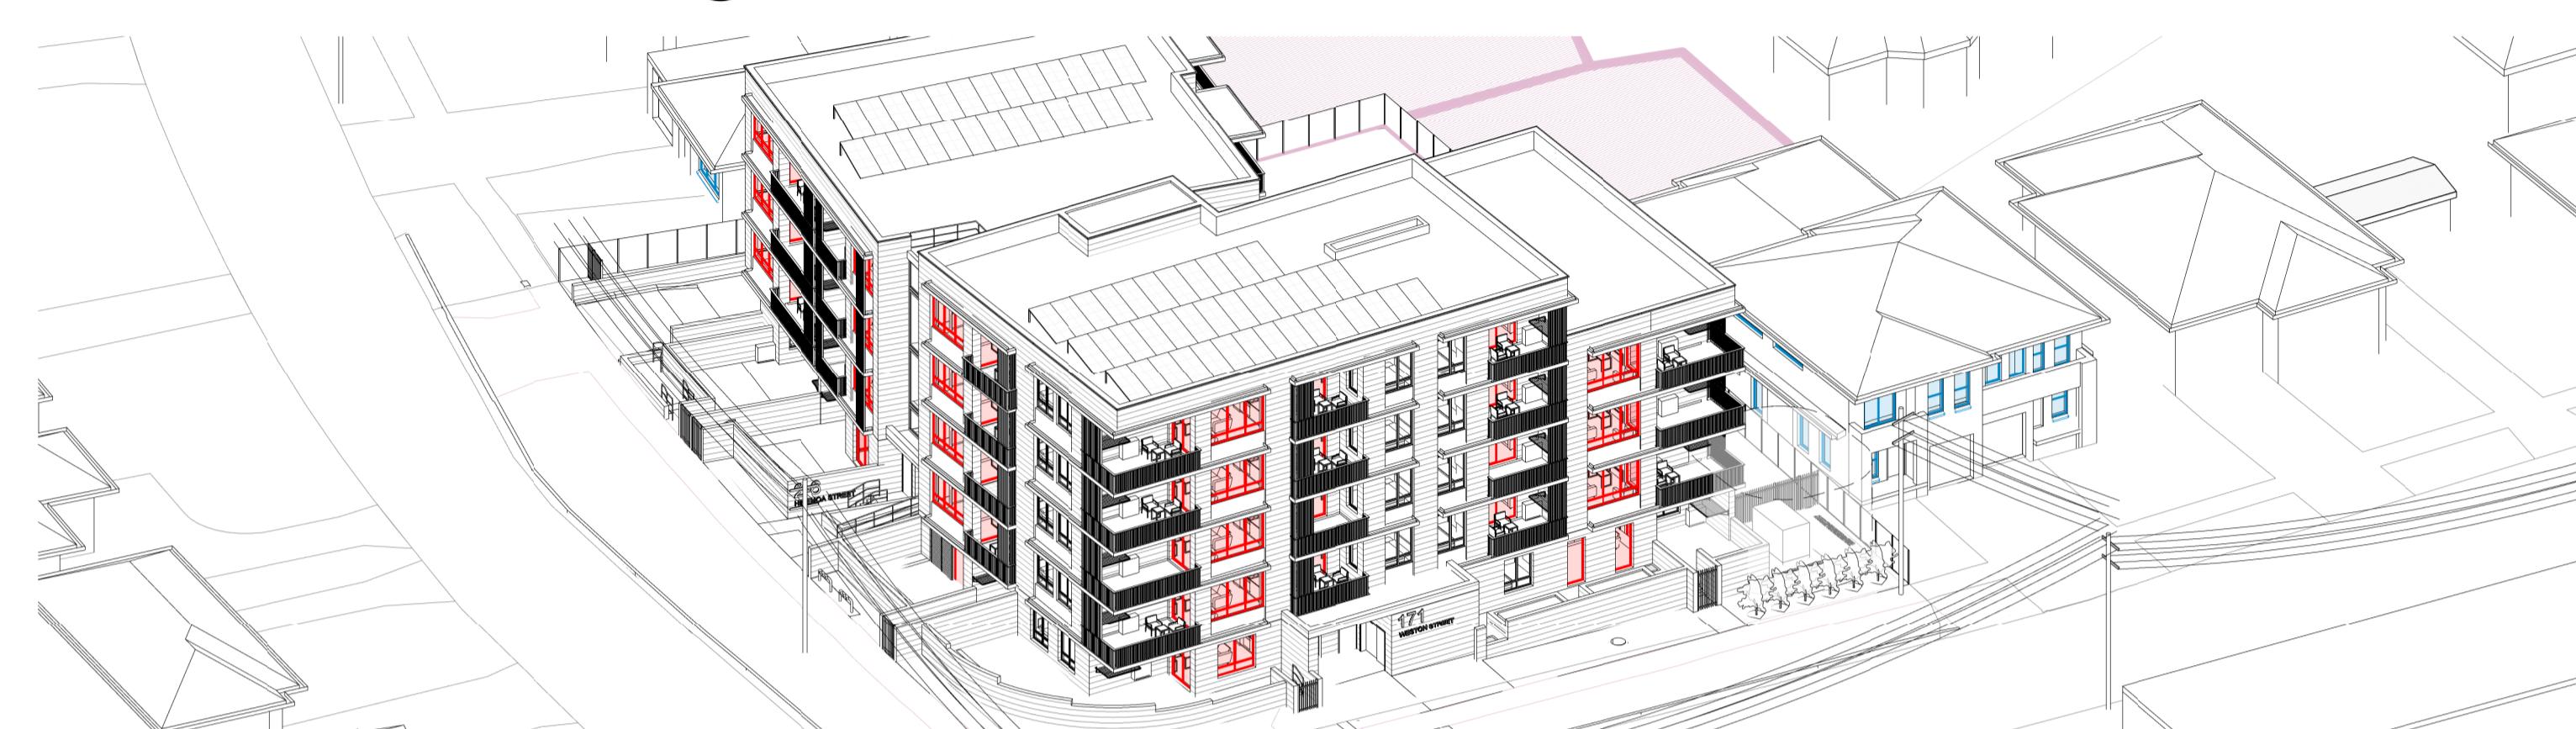

10:30 EYE FROM THE SUN - 10.30AM JUN

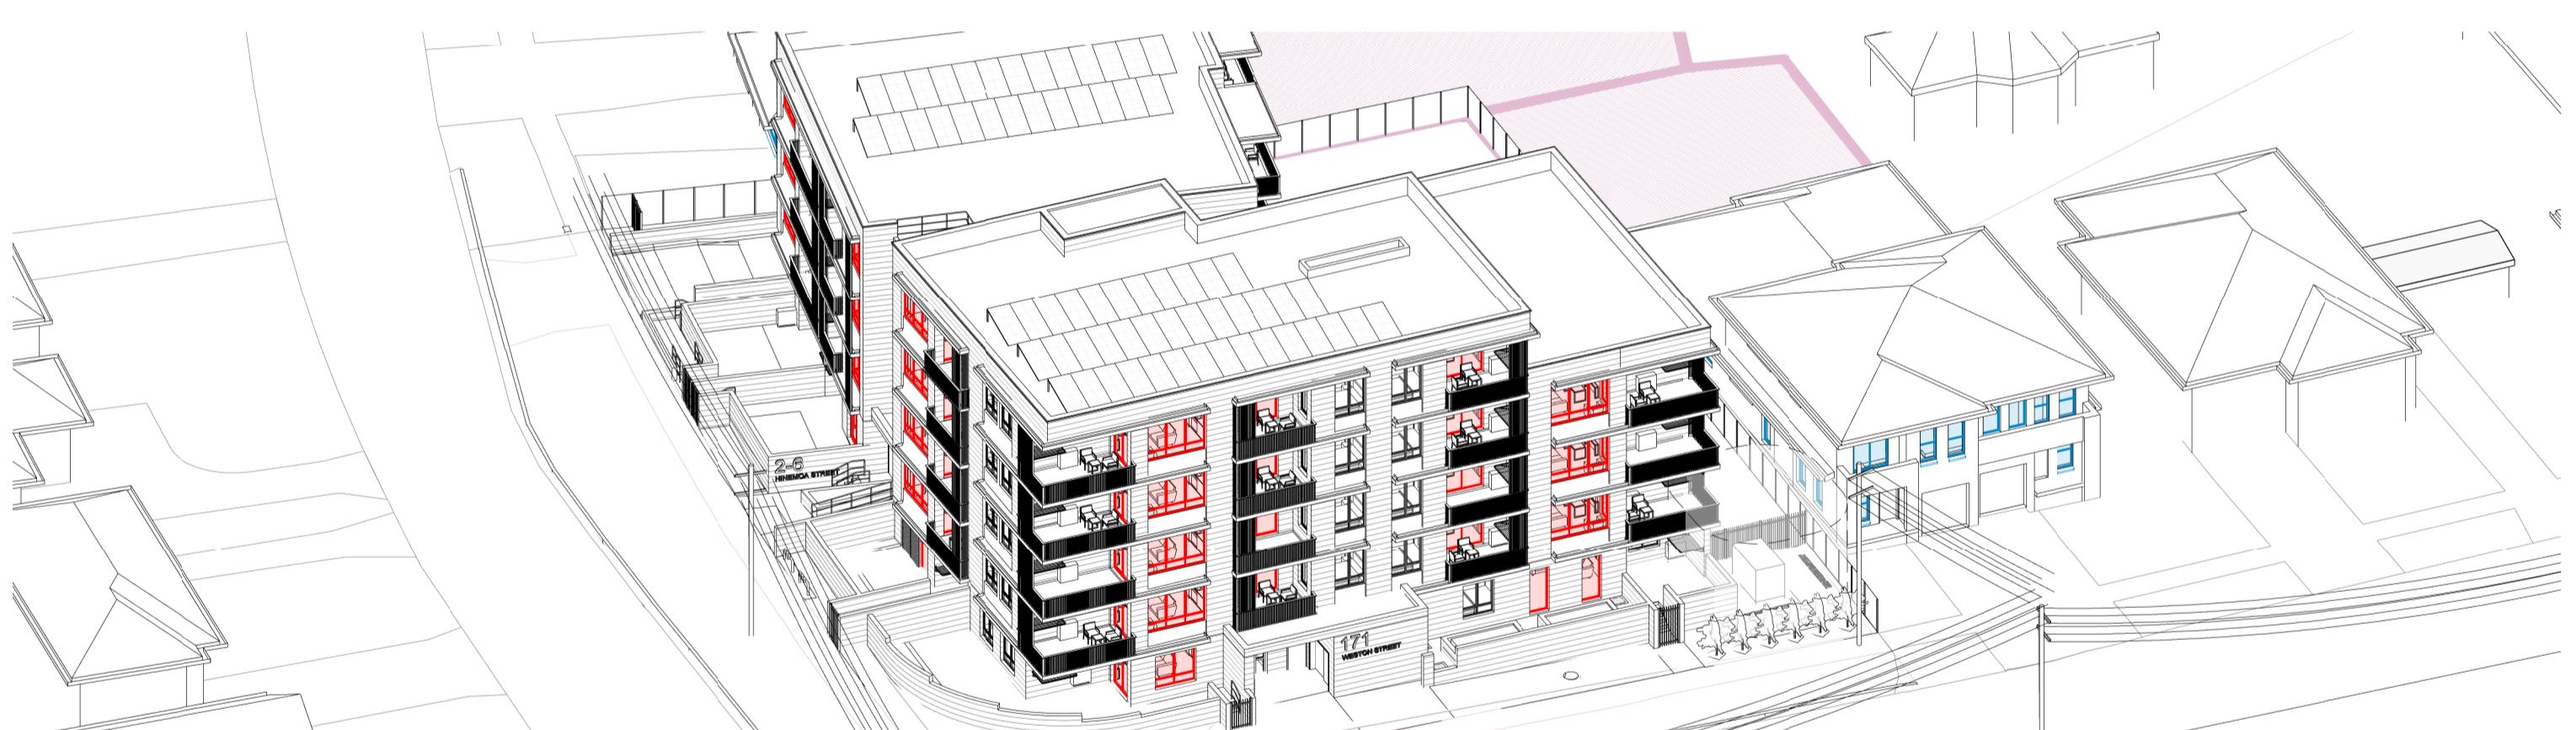

11AM EYE FROM THE SUN - 11AM JUN



11:30 EYE FROM THE SUN - 11.30AM JUN

| SOLAR ACCESS - GROUND FLOOR | | | | | | | | |
|-----------------------------|------------|------------|------------|------------|------------|------------|------------|------------|
| UNIT | UNIT 01 | UNIT 02 | UNIT 03 | UNIT 04 | UNIT 05 | UNIT 06 | UNIT 07 | UNIT 08 |
| LOCATION | LIVING POS |
| 9am - 10am | | | | | | | | |
| 10am - 11am | | | | | | | | |
| 11am - 12pm | | | | | | | | |
| 12pm - 1pm | | | | | | | | |
| 1pm - 2pm | | | | | | | | |
| 2pm - 3pm | | | | | | | | |

| SOLAR ACCESS - FIRST FLOOR | | | | | | | | |
|----------------------------|------------|------------|------------|------------|------------|------------|------------|------------|
| UNIT | UNIT 09 | UNIT 10 | UNIT 11 | UNIT 12 | UNIT 13 | UNIT 14 | UNIT 15 | UNIT 16 |
| LOCATION | LIVING POS |
| 9am - 10am | | | | | | | | |
| 10am - 11am | | | | | | | | |
| 11am - 12pm | | | | | | | | |
| 12pm - 1pm | | | | | | | | |
| 1pm - 2pm | | | | | | | | |
| 2pm - 3pm | | | | | | | | |

LIVING ROOM SOLAR ACCESS HOURS POS SOLAR ACCESS HOURS

| SOLAR ACCESS - SECOND FLOOR | | | | | | | | |
|-----------------------------|------------|------------|------------|------------|------------|------------|------------|------------|
| UNIT | UNIT 19 | UNIT 20 | UNIT 21 | UNIT 22 | UNIT 23 | UNIT 24 | UNIT 25 | UNIT 26 |
| LOCATION | LIVING POS |
| 9am - 10am | | | | | | | | |
| 10am - 11am | | | | | | | | |
| 11am - 12pm | | | | | | | | |
| 12pm - 1pm | | | | | | | | |
| 1pm - 2pm | | | | | | | | |
| 2pm - 3pm | | | | | | | | |

| SOLAR ACCESS - THIRD FLOOR | | | | | | | | |
|----------------------------|------------|------------|------------|------------|------------|------------|------------|------------|
| UNIT | UNIT 29 | UNIT 30 | UNIT 31 | UNIT 32 | UNIT 33 | UNIT 34 | UNIT 35 | UNIT 36 |
| LOCATION | LIVING POS |
| 9am - 10am | | | | | | | | |
| 10am - 11am | | | | | | | | |
| 11am - 12pm | | | | | | | | |
| 12pm - 1pm | | | | | | | | |
| 1pm - 2pm | | | | | | | | |
| 2pm - 3pm | | | | | | | | |

| SOLAR ACCESS - FOURTH FLOOR | | | | |
|-----------------------------|------------|------------|------------|------------|
| UNIT | UNIT 39 | UNIT 40 | UNIT 41 | UNIT 42 |
| LOCATION | LIVING POS | LIVING POS | LIVING POS | LIVING POS |
| 9am - 10am | | | | |
| 10am - 11am | | | | |
| 11am - 12pm | | | | |
| 12pm - 1pm | | | | |
| 1pm - 2pm | | | | |
| 2pm - 3pm | | | | |

| ISSUE | DATE | AMENDMENT | |
|-------|------------|-----------|--|
| A | 2024-08-30 | DA ISSUE | |

LEGEND
■ LIVING ROOM WINDOWS
■ WINDOW TO NEIGHBOURING DWELLING
■ PRIVATE OPEN SPACE TO NEIGHBOURING DWELLING

PROJECT
PANANIA - LAHC 2021/505
ADDRESS
171 Weston St & 2-6 Hinemoa St, Panania, NSW, 2213
LOT 42, 43, 44, 45 / DP35211

CLIENT
NSW
GOVERNMENT
LOCKED BAG 5022
171 Weston St & 2-6 Hinemoa St, Panania, NSW, 2213
PHONE 1800 738 718

PROJECT No.
21042
CLIENT
LAHC

MORSON
GROUP

NOMINATED ARCHITECT - P.F.
MORSON REGISTRATION NUMBER 8100
ACN 159 480 056, ABN A159 480 056
T: (02) 9380 4466, F: (02) 9380 4466
PO Box 170, Potts Point, NSW 1133

SHEET SIZE: A1
NAME: SOLAR STUDY - SHEET 1
SCALE: 1:2

DRAWING No.
DA23
ISSUE No.
A



12PM EYE FROM THE SUN - 12PM JUN




12.30 EYE FROM THE SUN - 12.30PM JUN




1PM EYE FROM THE SUN - 1PM JUN




1.30 EYE FROM THE SUN - 1.30PM JUN

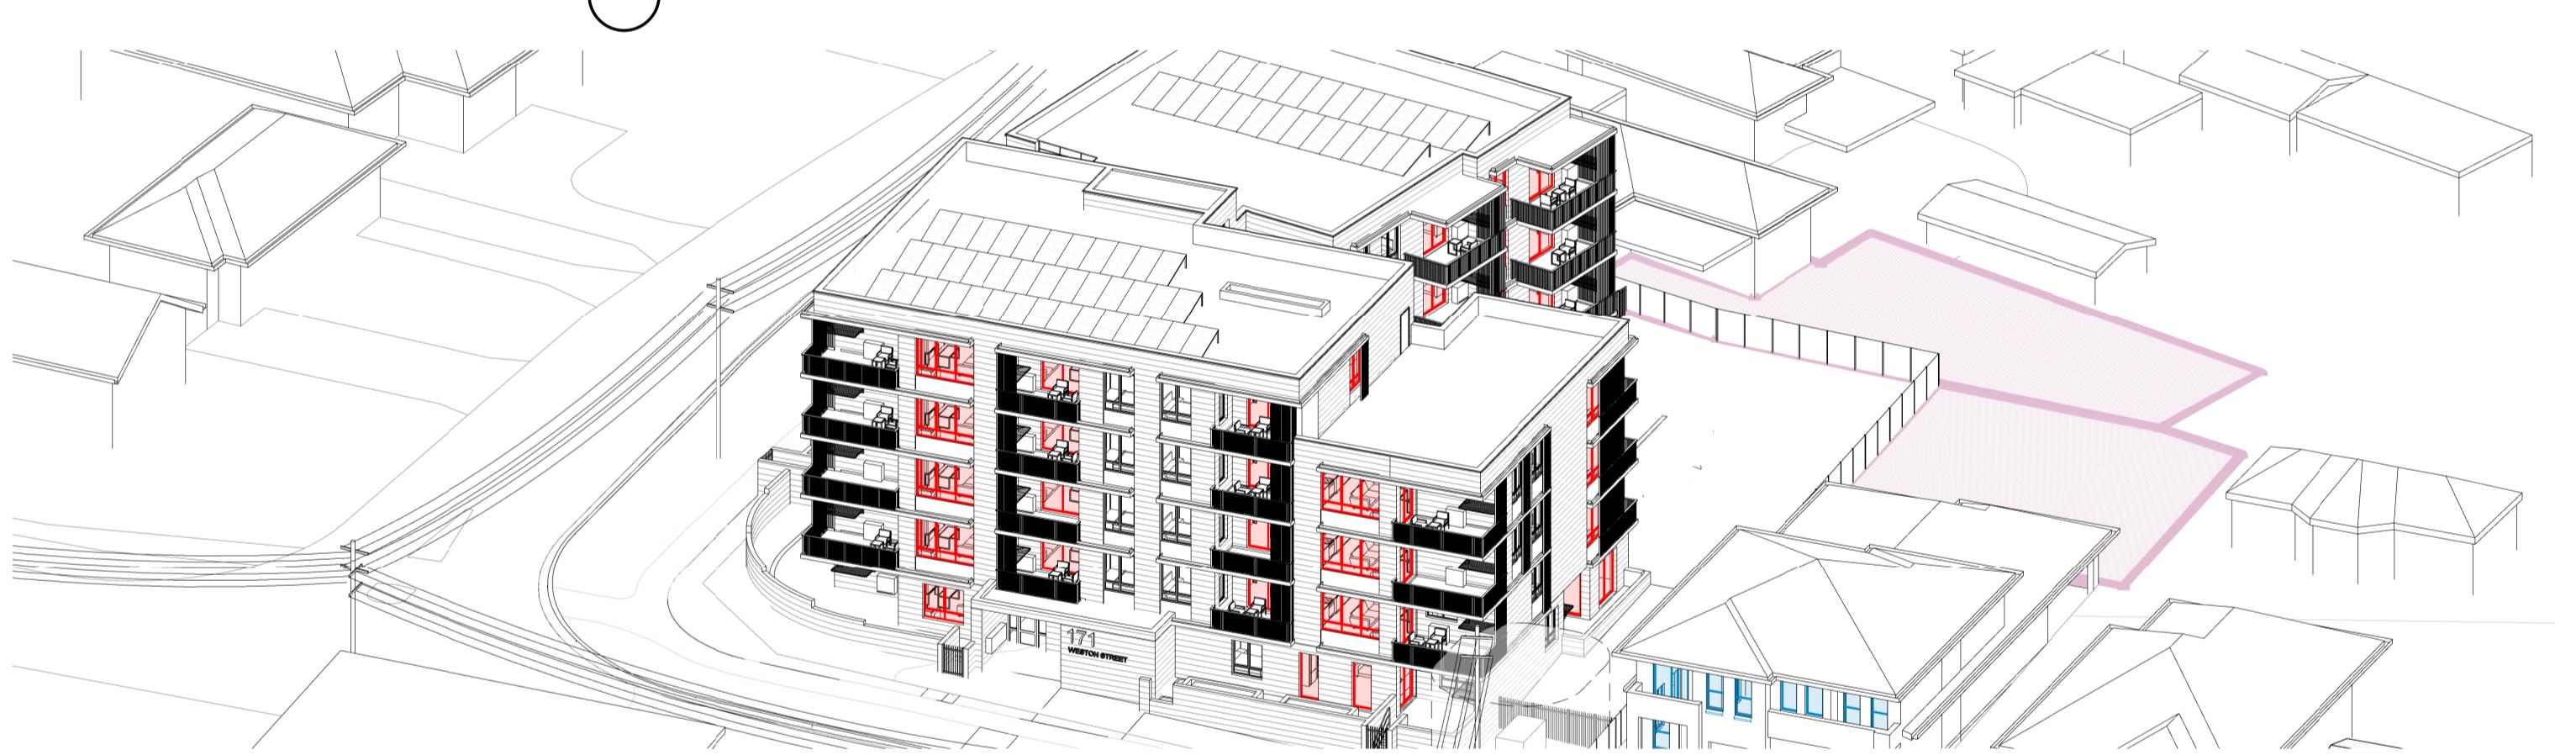

2PM EYE FROM THE SUN - 2PM JUN

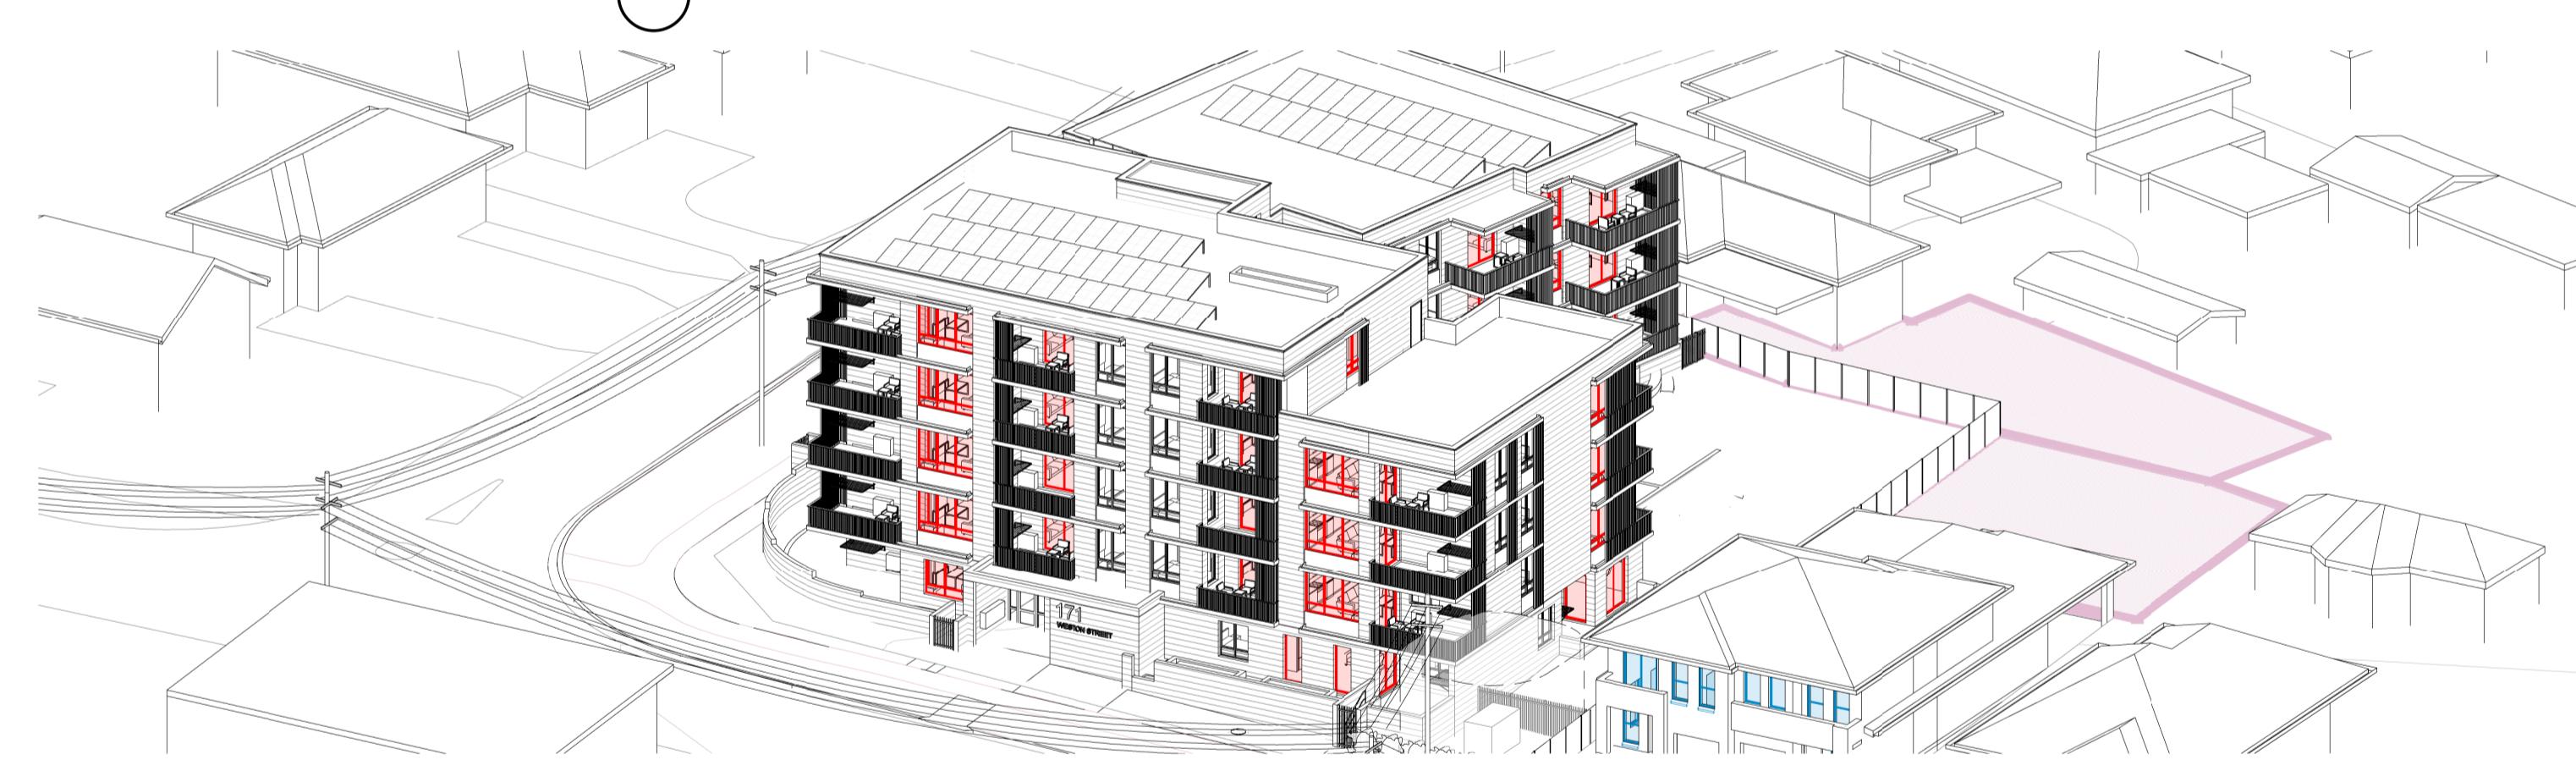

2.30 EYE FROM THE SUN - 2.30PM JUN

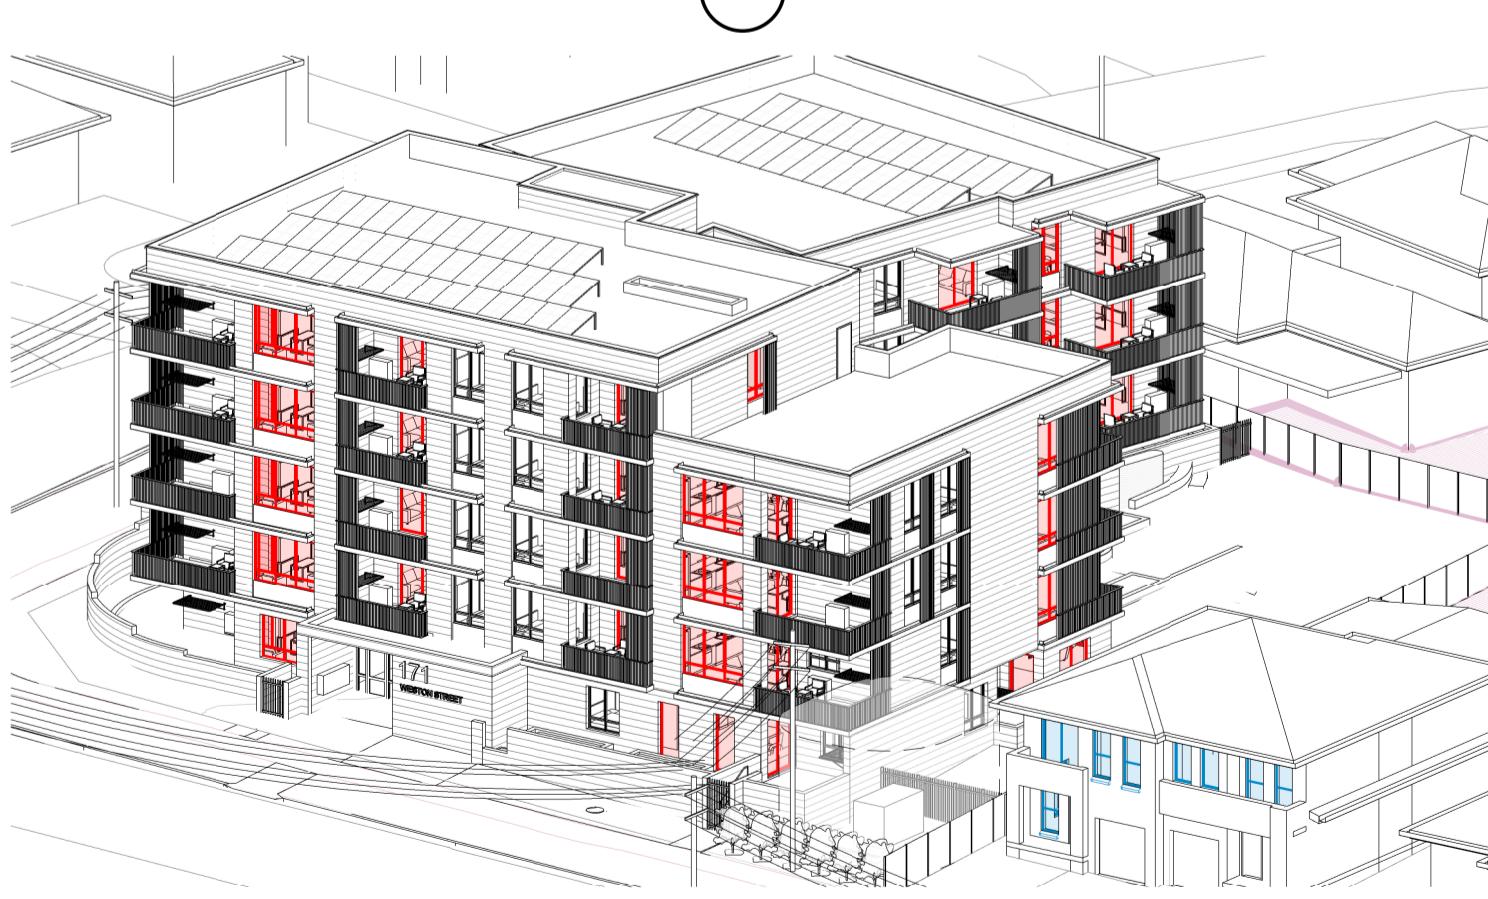

3PM EYE FROM THE SUN - 3PM JUN

| SOLAR ACCESS - GROUND FLOOR | | | | | | | | |
|-----------------------------|------------|------------|------------|------------|------------|------------|------------|------------|
| UNIT | UNIT 01 | UNIT 02 | UNIT 03 | UNIT 04 | UNIT 05 | UNIT 06 | UNIT 07 | UNIT 08 |
| LOCATION | LIVING POS |
| 9am - 10am | | | | | | | | |
| 10am - 11am | | | | | | | | |
| 11am - 12pm | | | | | | | | |
| 12pm - 1pm | | | | | | | | |
| 1pm - 2pm | | | | | | | | |
| 2pm - 3pm | | | | | | | | |

| SOLAR ACCESS - FIRST FLOOR | | | | | | | | |
|----------------------------|------------|------------|------------|------------|------------|------------|------------|------------|
| UNIT | UNIT 09 | UNIT 10 | UNIT 11 | UNIT 12 | UNIT 13 | UNIT 14 | UNIT 15 | UNIT 16 |
| LOCATION | LIVING POS |
| 9am - 10am | | | | | | | | |
| 10am - 11am | | | | | | | | |
| 11am - 12pm | | | | | | | | |
| 12pm - 1pm | | | | | | | | |
| 1pm - 2pm | | | | | | | | |
| 2pm - 3pm | | | | | | | | |

LIVING ROOM SOLAR ACCESS HOURS POS SOLAR ACCESS HOURS

| SOLAR ACCESS - SECOND FLOOR | | | | | | | | |
|-----------------------------|------------|------------|------------|------------|------------|------------|------------|------------|
| UNIT | UNIT 19 | UNIT 20 | UNIT 21 | UNIT 22 | UNIT 23 | UNIT 24 | UNIT 25 | UNIT 26 |
| LOCATION | LIVING POS |
| 9am - 10am | | | | | | | | |
| 10am - 11am | | | | | | | | |
| 11am - 12pm | | | | | | | | |
| 12pm - 1pm | | | | | | | | |
| 1pm - 2pm | | | | | | | | |
| 2pm - 3pm | | | | | | | | |

| SOLAR ACCESS - THIRD FLOOR | | | | | | | | |
|----------------------------|------------|------------|------------|------------|------------|------------|------------|------------|
| UNIT | UNIT 29 | UNIT 30 | UNIT 31 | UNIT 32 | UNIT 33 | UNIT 34 | UNIT 35 | UNIT 36 |
| LOCATION | LIVING POS |
| 9am - 10am | | | | | | | | |
| 10am - 11am | | | | | | | | |
| 11am - 12pm | | | | | | | | |
| 12pm - 1pm | | | | | | | | |
| 1pm - 2pm | | | | | | | | |
| 2pm - 3pm | | | | | | | | |

| SOLAR ACCESS - FOURTH FLOOR | | | | |
|-----------------------------|------------|------------|------------|------------|
| UNIT | UNIT 39 | UNIT 40 | UNIT 41 | UNIT 42 |
| LOCATION | LIVING POS | LIVING POS | LIVING POS | LIVING POS |
| 9am - 10am | | | | |
| 10am - 11am | | | | |
| 11am - 12pm | | | | |
| 12pm - 1pm | | | | |
| 1pm - 2pm | | | | |
| 2pm - 3pm | | | | |

| ISSUE | DATE | AMENDMENT | |
|-------|------------|-----------|--|
| A | 2024-08-30 | DA ISSUE | |
| | | | |

LEGEND
■ LIVING ROOM WINDOWS
■ WINDOW TO NEIGHBOURING DWELLING
■ PRIVATE OPEN SPACE TO NEIGHBOURING DWELLING

PROJECT
PANANIA - LAHC 2021/505
ADDRESS
171 Weston St & 2-6 Hinemoa St, Panania, NSW, 2213
LOT 42, 43, 44, 45 / DP35211







CLIENT
NSW LAHC
LOCKED BAG 5022
171 Weston St & 2-6 Hinemoa St, Panania, NSW, 2213
PHONE 1800 738 718

PROJECT No.
21042
CLIENT
LAHC


NOMINATED ARCHITECT - P.F.
MORSON GROUP • NSW GOVERNMENT
REGISTRATION NUMBER 8100
ACN 159 480 056, ABN 41 159 480 056
(02) 9380 4946
PO Box 170, Poft Point, NSW 1335

SHEET
SIZE: A1
NAME: SOLAR STUDY - SHEET 2
SCALE:
1:2

DRAWING No.
DA24
ISSUE No.
A

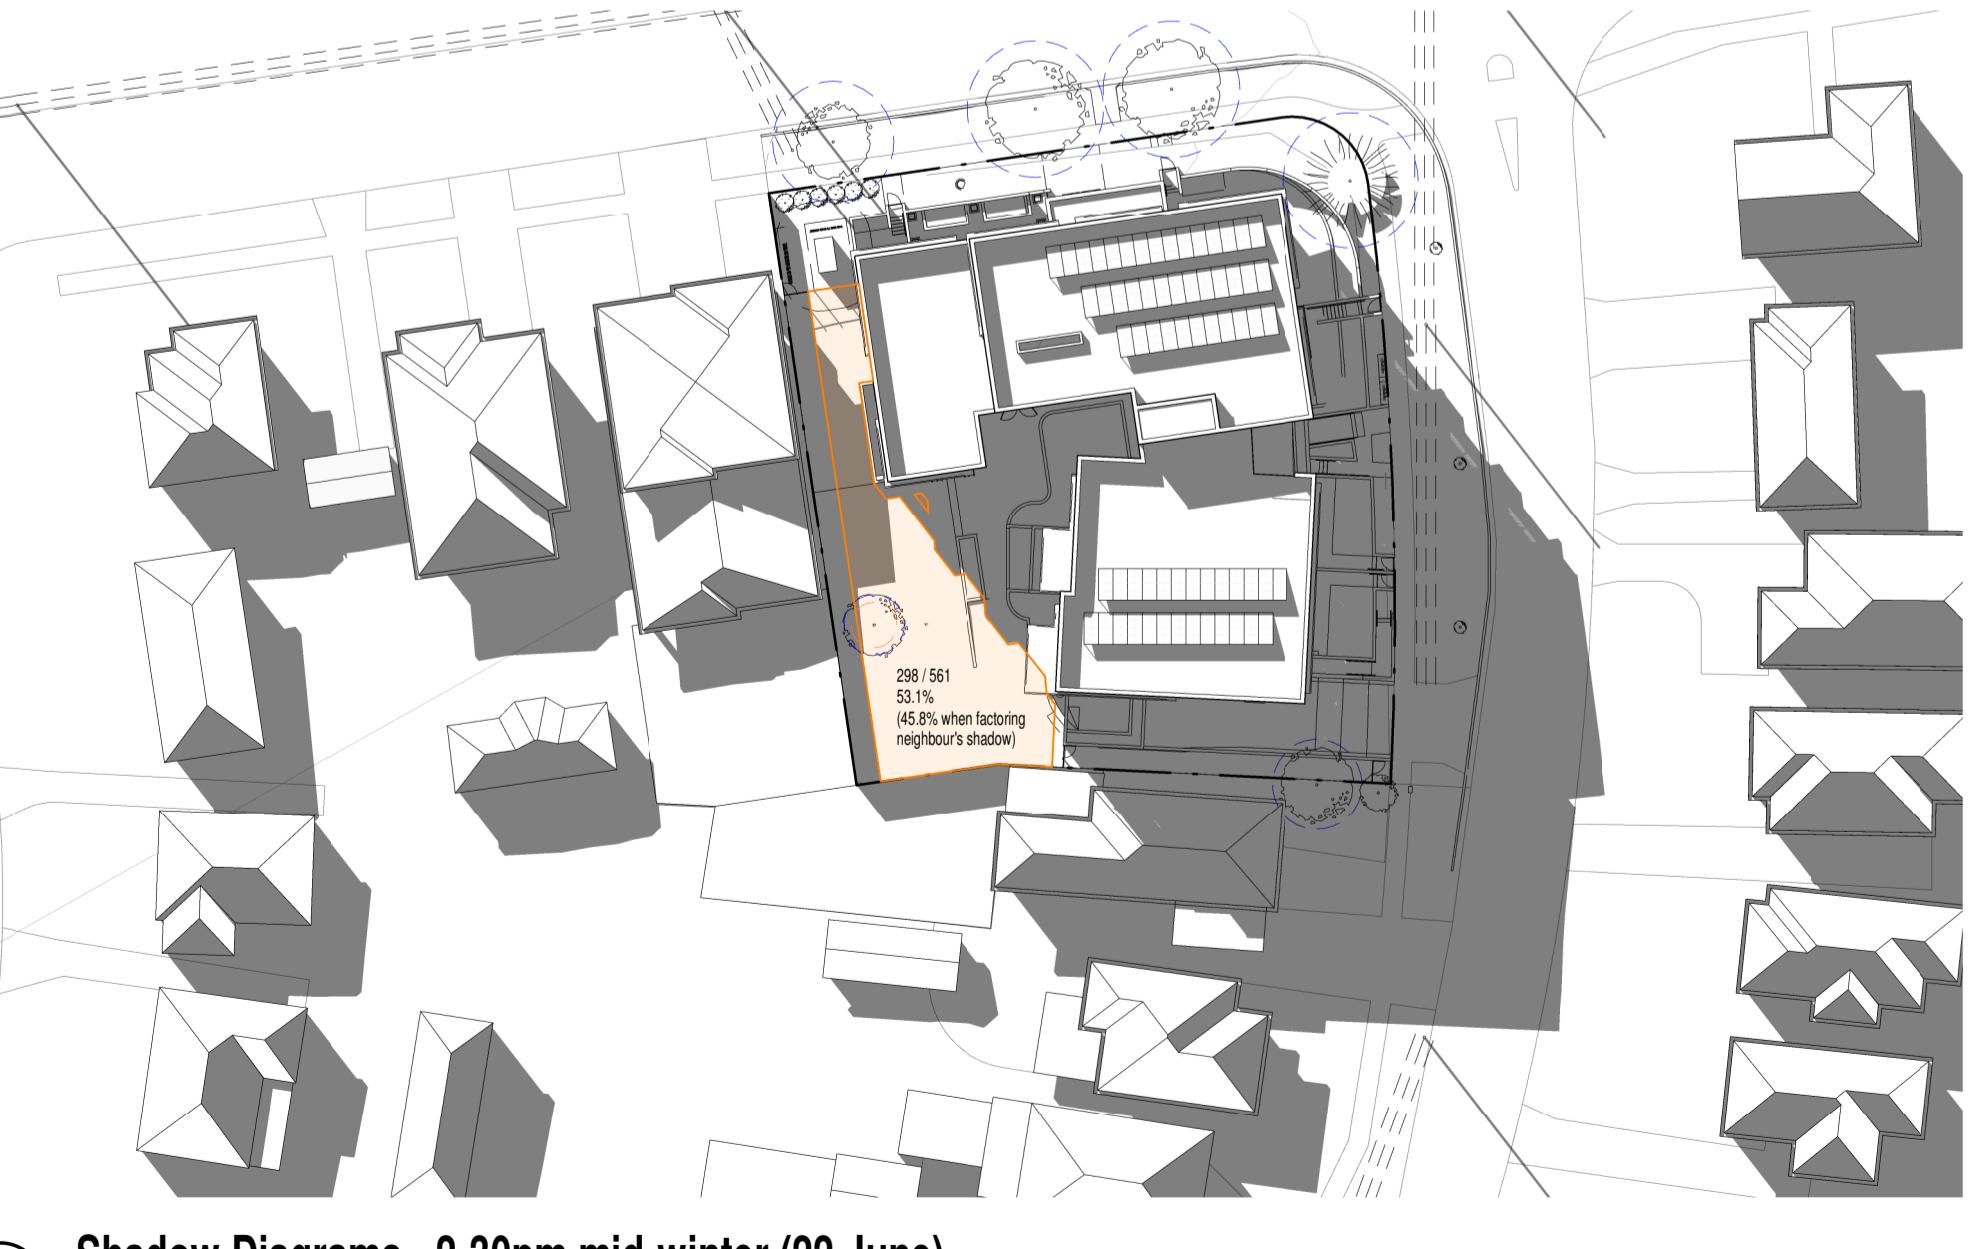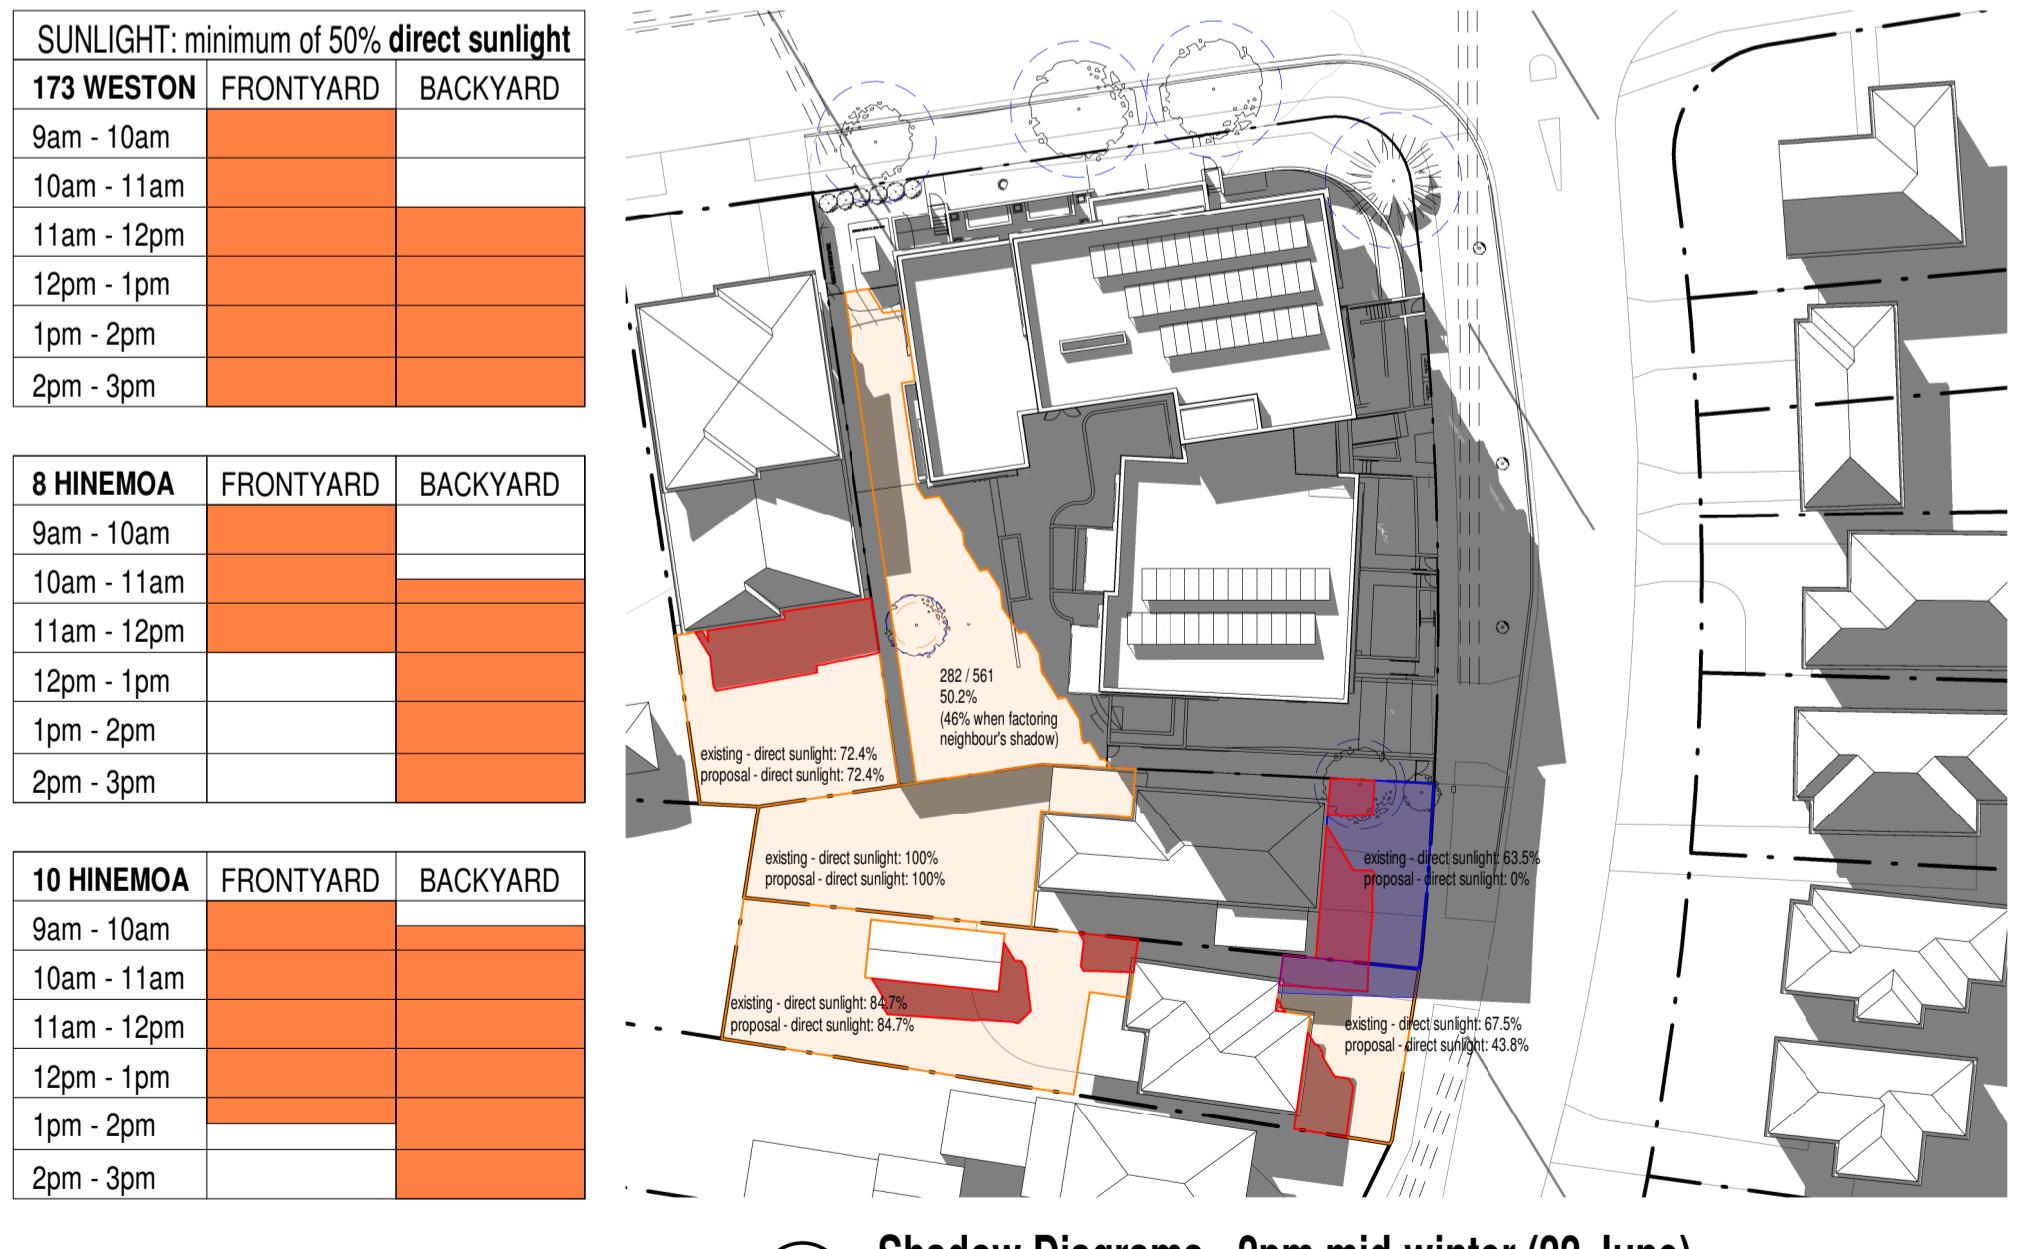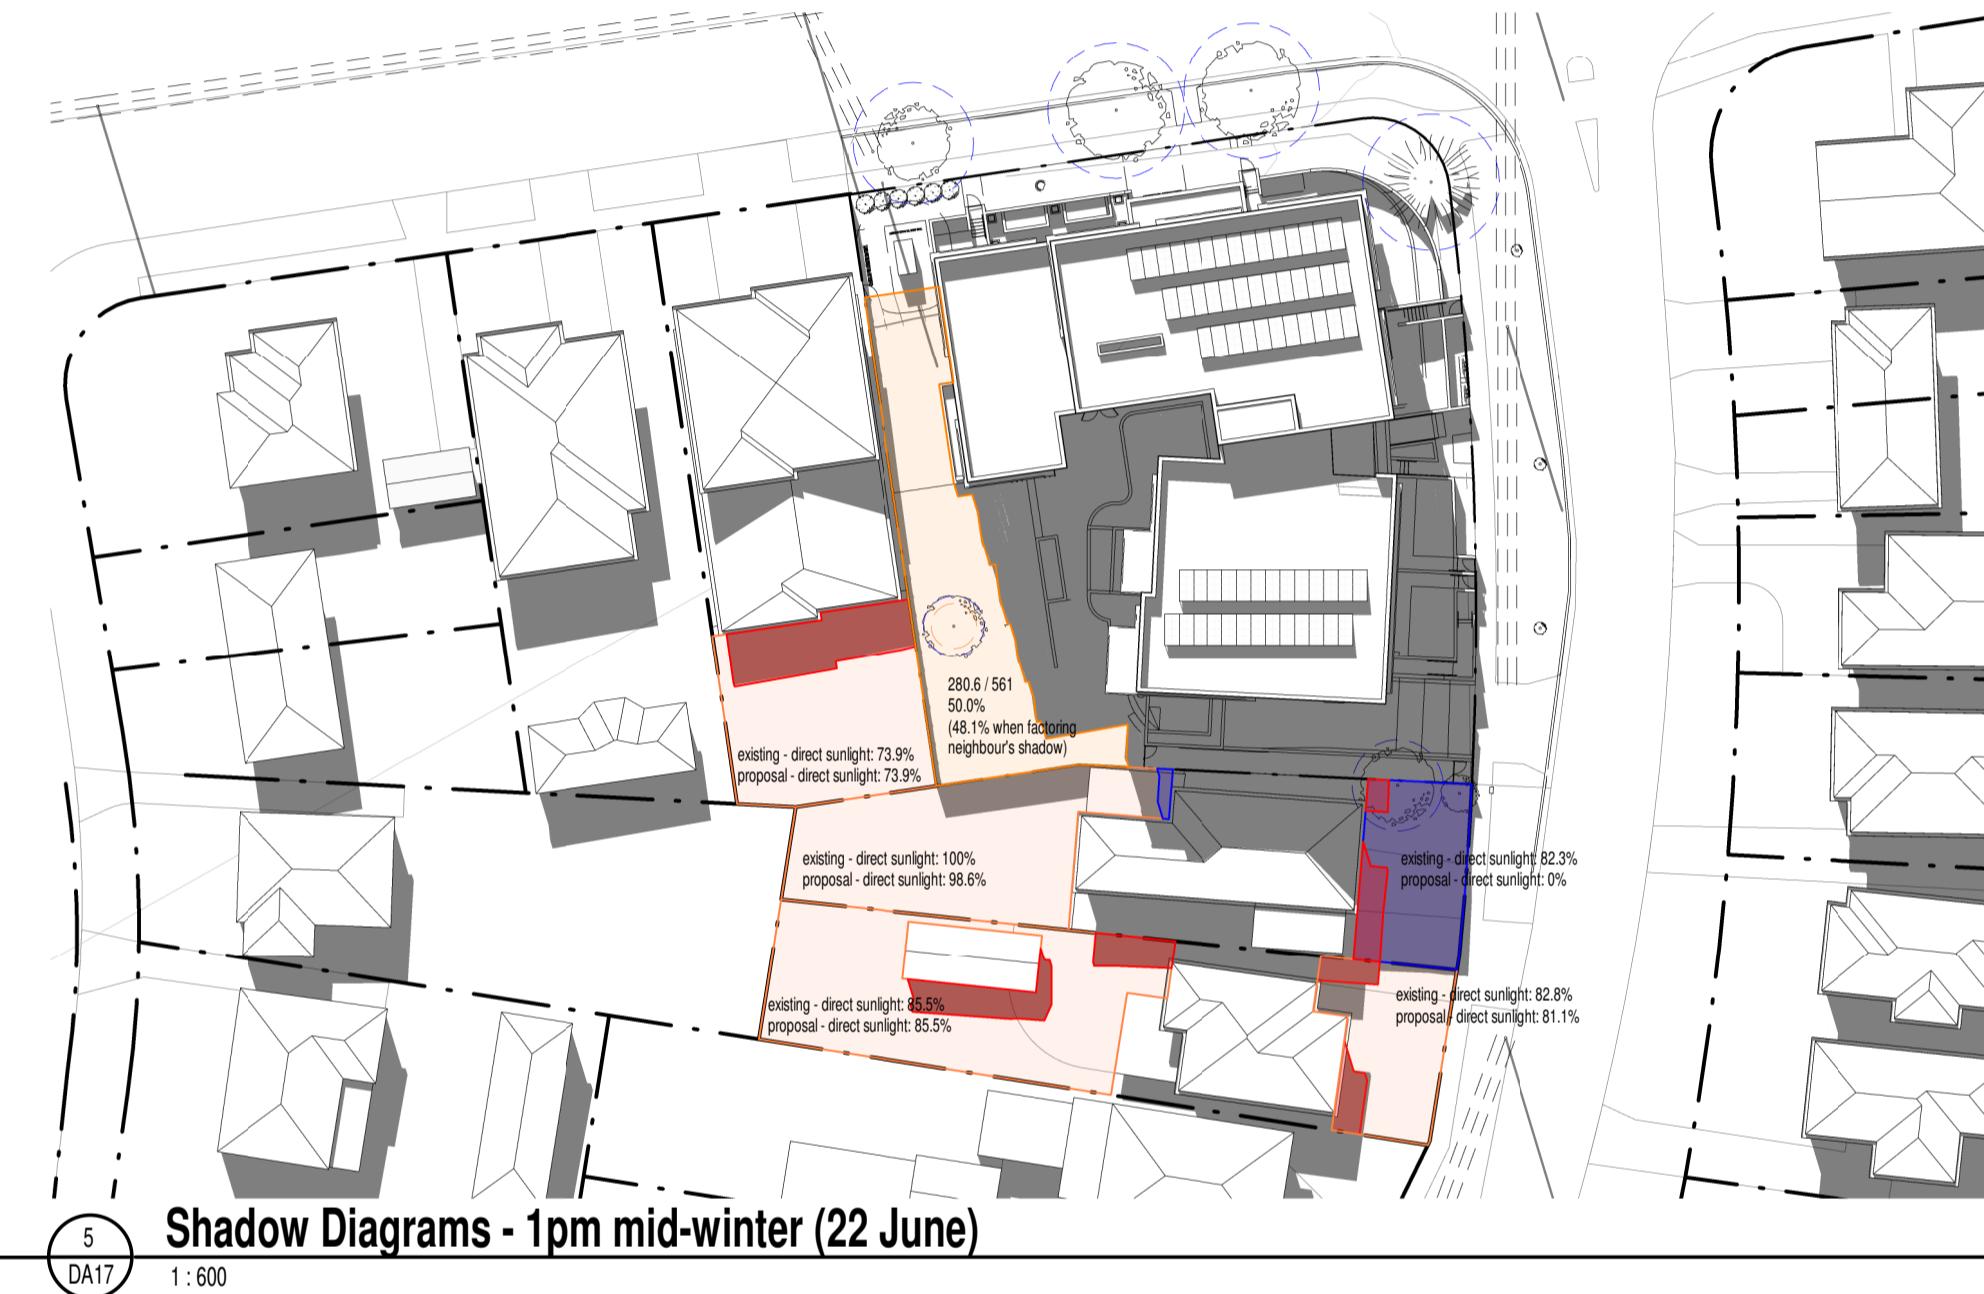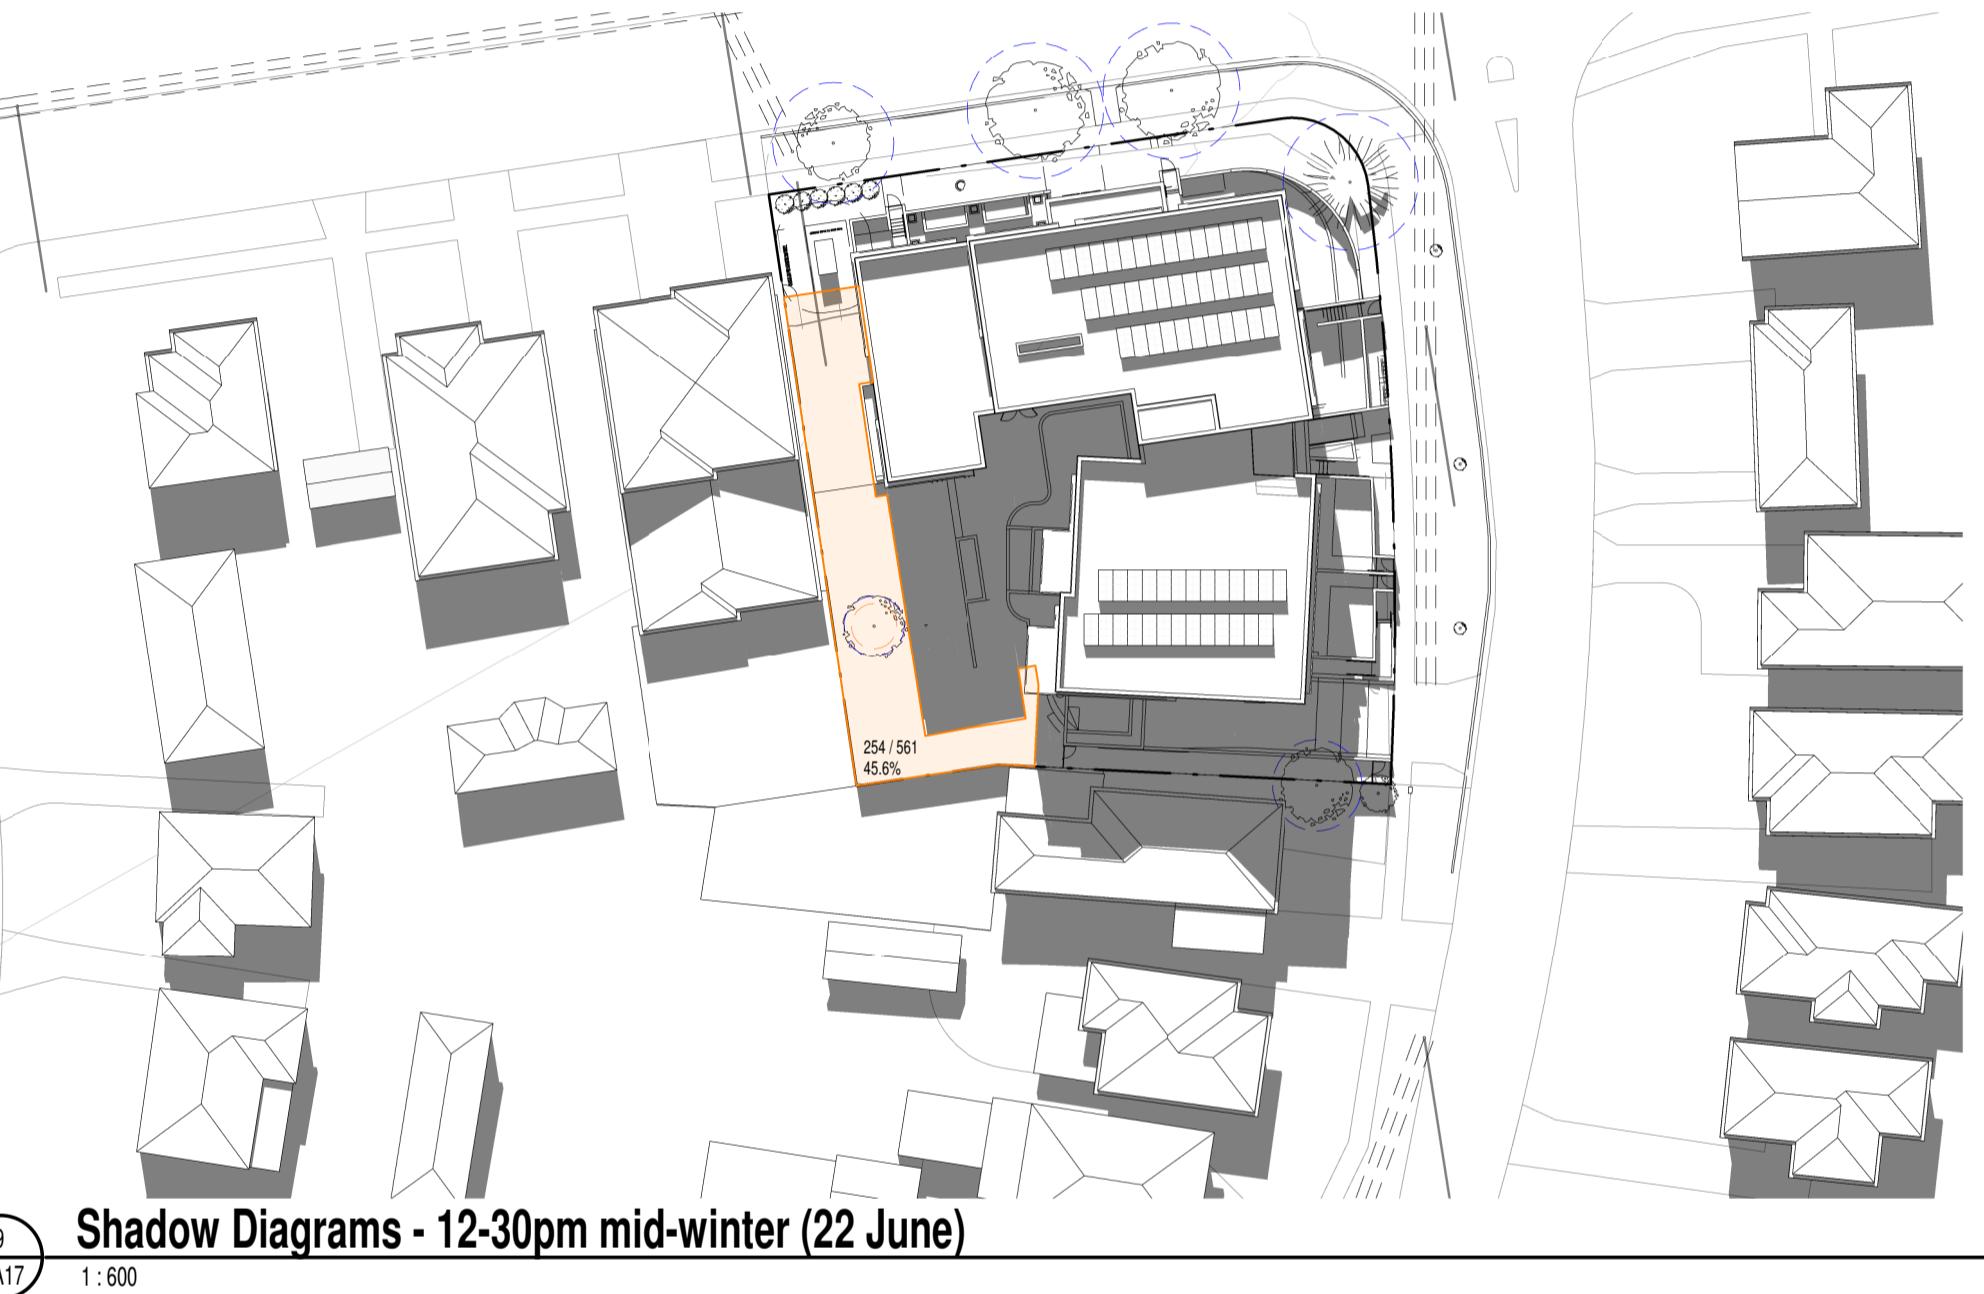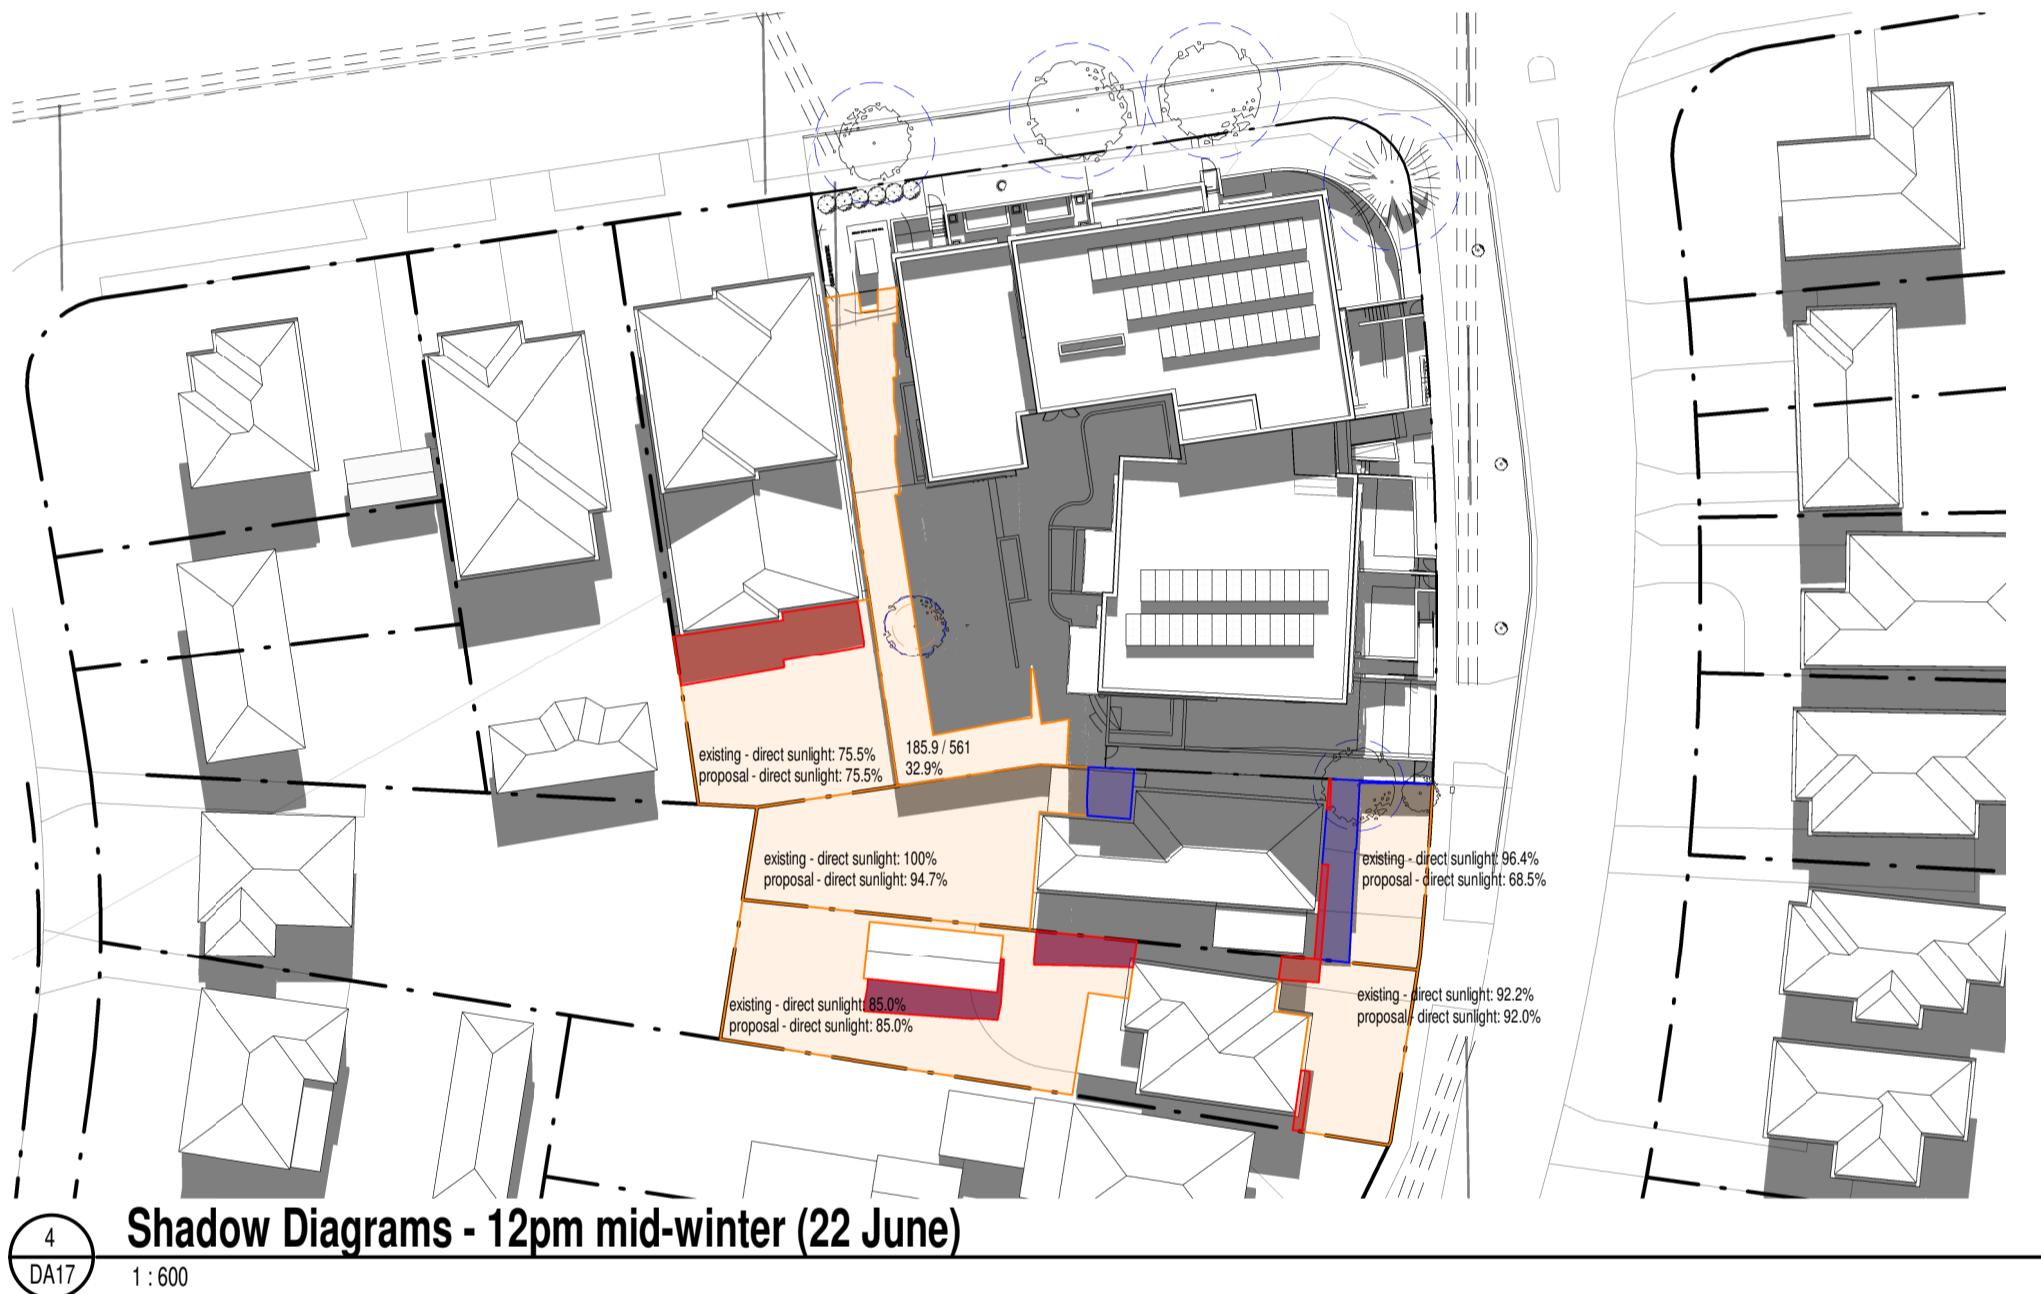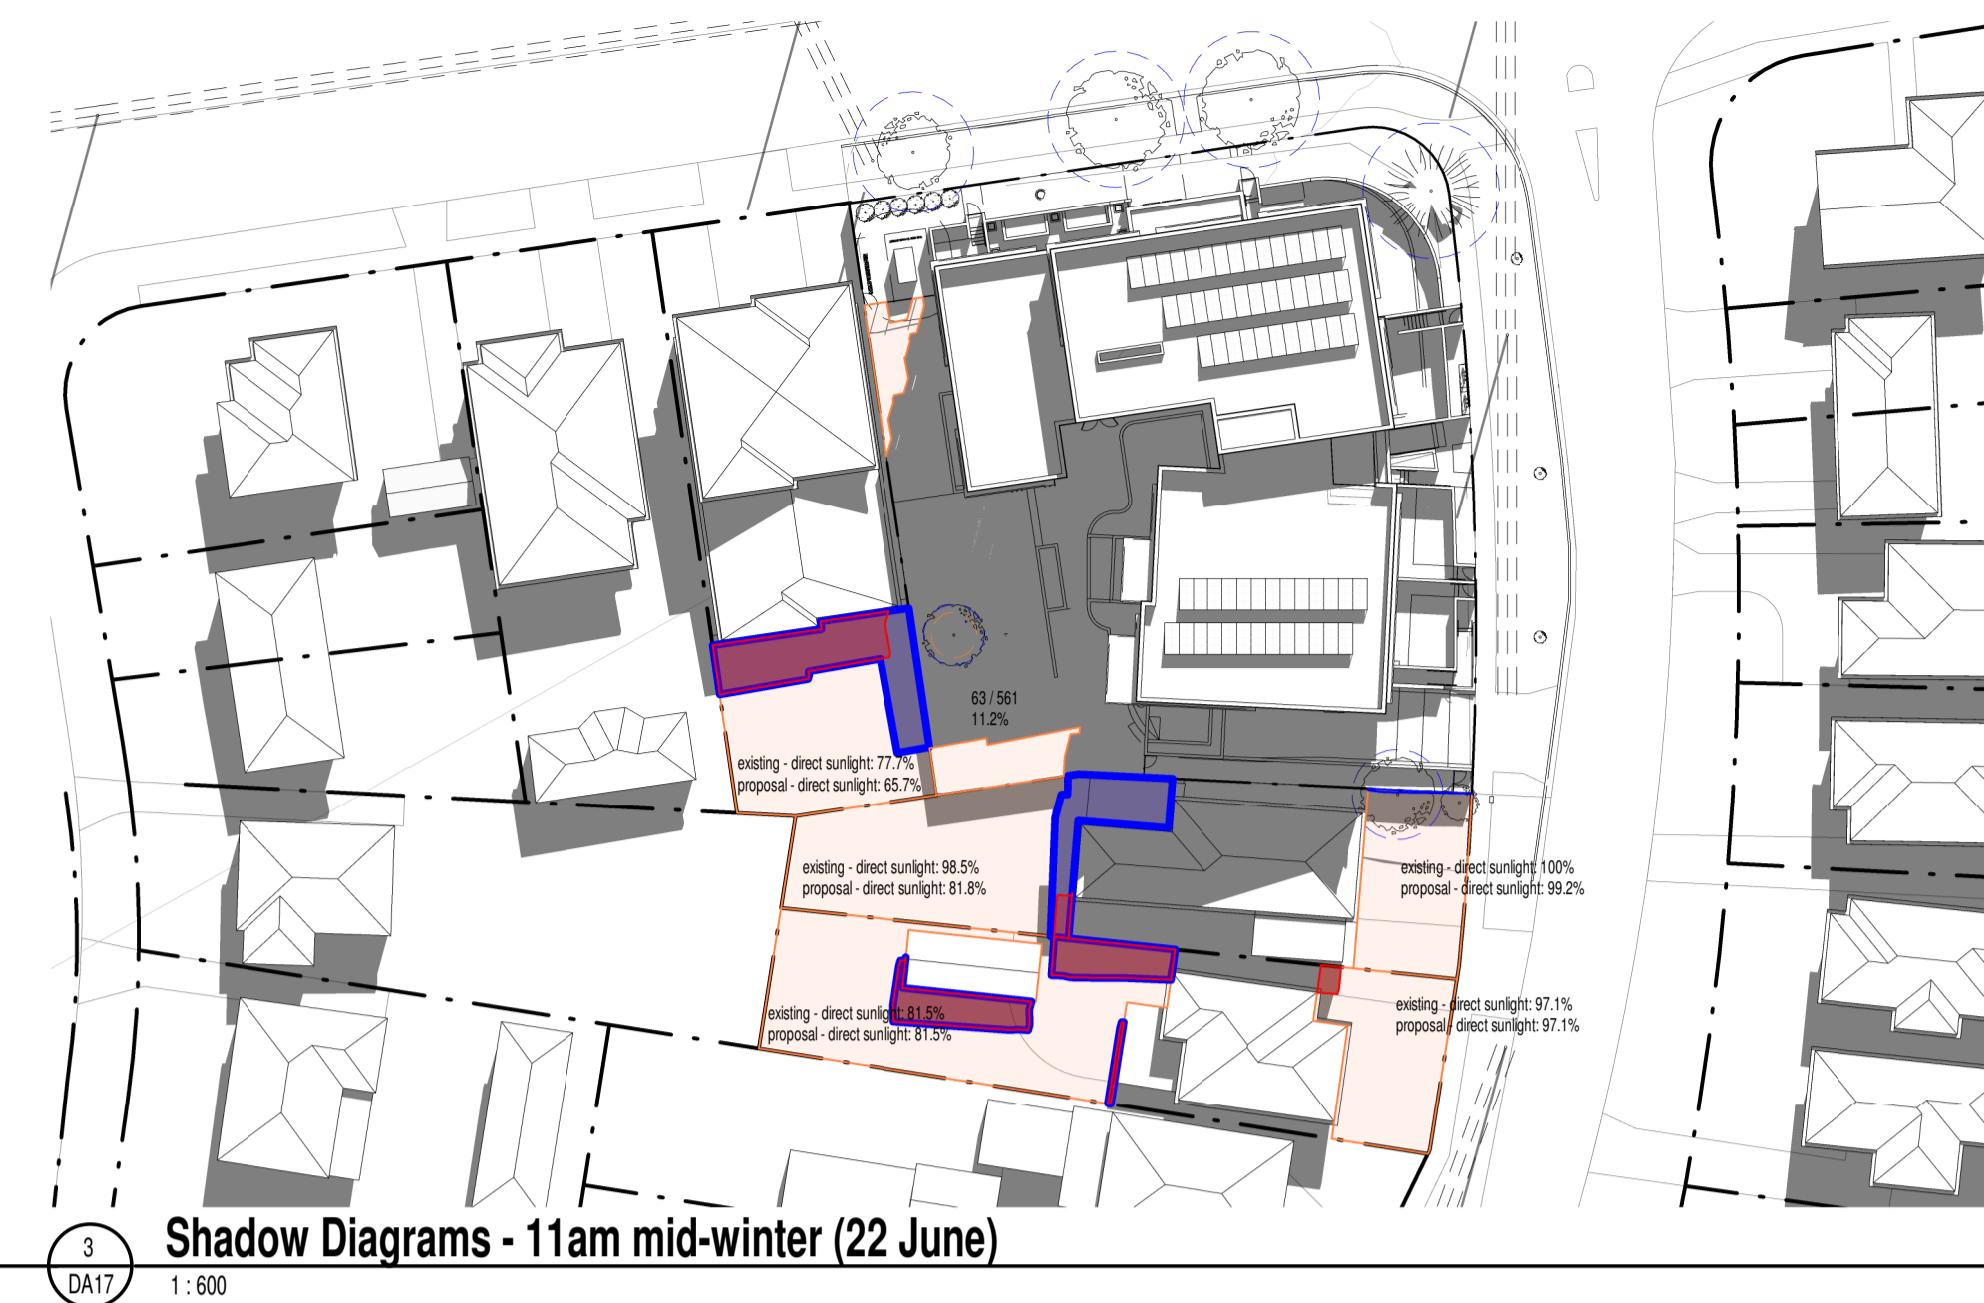

| ISSUE | DATE | AMENDMENT |
|-------|------------|-----------|
| A | 2024-08-30 | DA ISSUE |

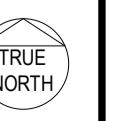

PROJECT
PANANIA - LAHC 2021/505
ADDRESS
171 Weston St & 2-6 Hinemoa St, Panania, NSW, 2213 PARRAMATTA NSW 2124
LOT 42, 43, 44, 45 / DP35211

CLIENT
NSW LAHC
LOCKED BAG 5022
ACN 139 480 056, ABN 41 139 480 056
PHONE 1800 738 718

PROJECT No.
21042



NOMINATED ARCHITECT - P.F.
MORSON GROUP PTY LTD
ACN 139 480 056, ABN 41 139 480 056
(02) 9380 4946
PO Box 170, Potts Point, NSW 1133

SHEET SIZE: A1 SHEET NAME: **SHADOW DIAGRAMS**
SCALE: As indicated

DRAWING No.
DA25
ISSUE No.
A



| ISSUE | DATE | AMENDMENT |
|-------|------------|-----------|
| A | 2024-08-30 | DA ISSUE |



TRUE
NORTH

0 1 2 3 4 5 7

10m

(1:200@A1)

SCALE 1:100@A1

0 1 2 3 4 5 7

10m

(1:200@A3)

SCALE 1:100@A3


PROJECT
PANANIA - LAHC 2021/505
CLIENT
NSW LAHC
ADDRESS
171 Weston St & 2-6 Hinemoa St, Panania, NSW, 2213
LOT 42, 43, 44, 45 / DP35211
PHONE 1800 738 718

PROJECT No.
21042
CLIENT
LAHC
NSW
GOVERNMENT

NOMINATED ARCHITECT - P.F.
MORSON GROUP PTY LTD
ACN 159 480 056, ABN 47 159 480 056
(02) 9380 4946
PO Box 170, Potts Point, NSW 1135

DRAWING No.
DA26
ISSUE No.
A


SHEET
NAME: **CUT - FILL PLAN**
SHEET
SIZE: A1
SCALE:
1 : 100

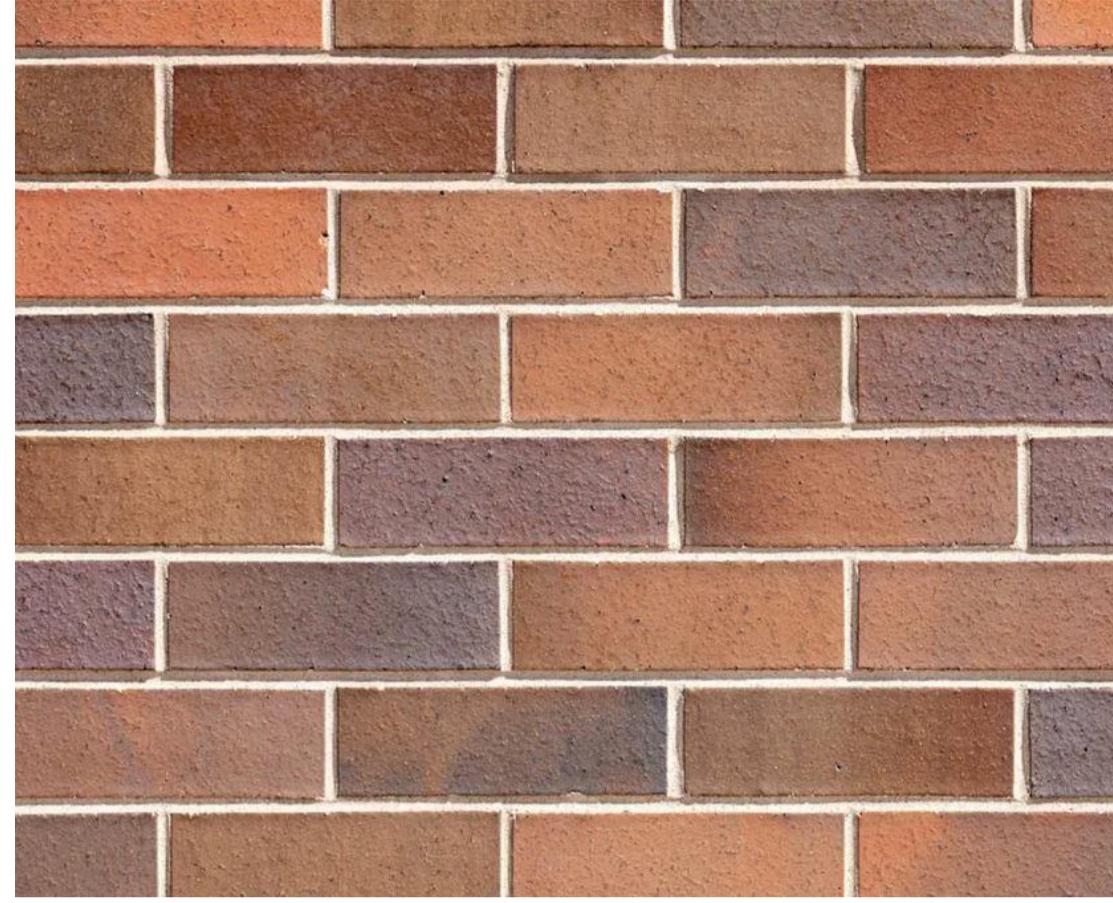


FBK1
Face Brickwork
From level 1 to level 4
AUSTRALBRICKS
PARK LANE
GROSVENOR BRICK
230x76-110-240-NAT



FBK2
Face Brickwork
Terraces and ground
AUSTRALBRICKS
BOWRAL BLUE BRICK
230x76-110-240-NAT

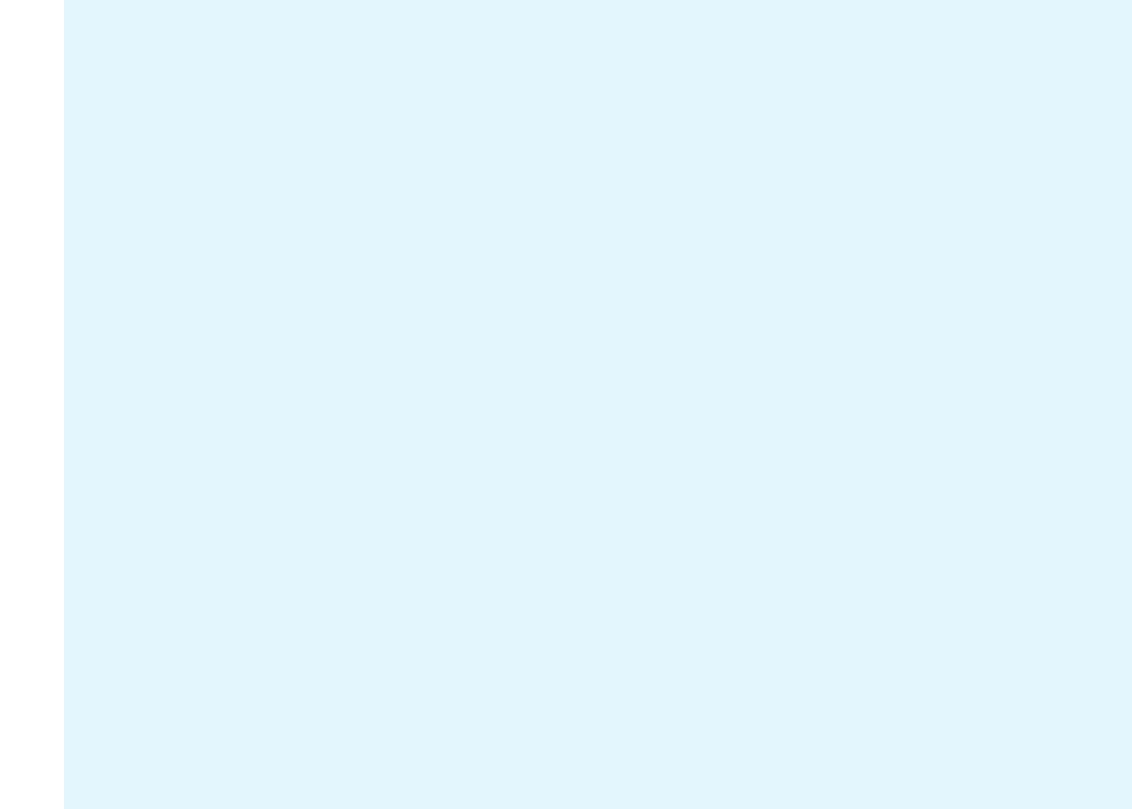

GL1
Windows
Clear Glass

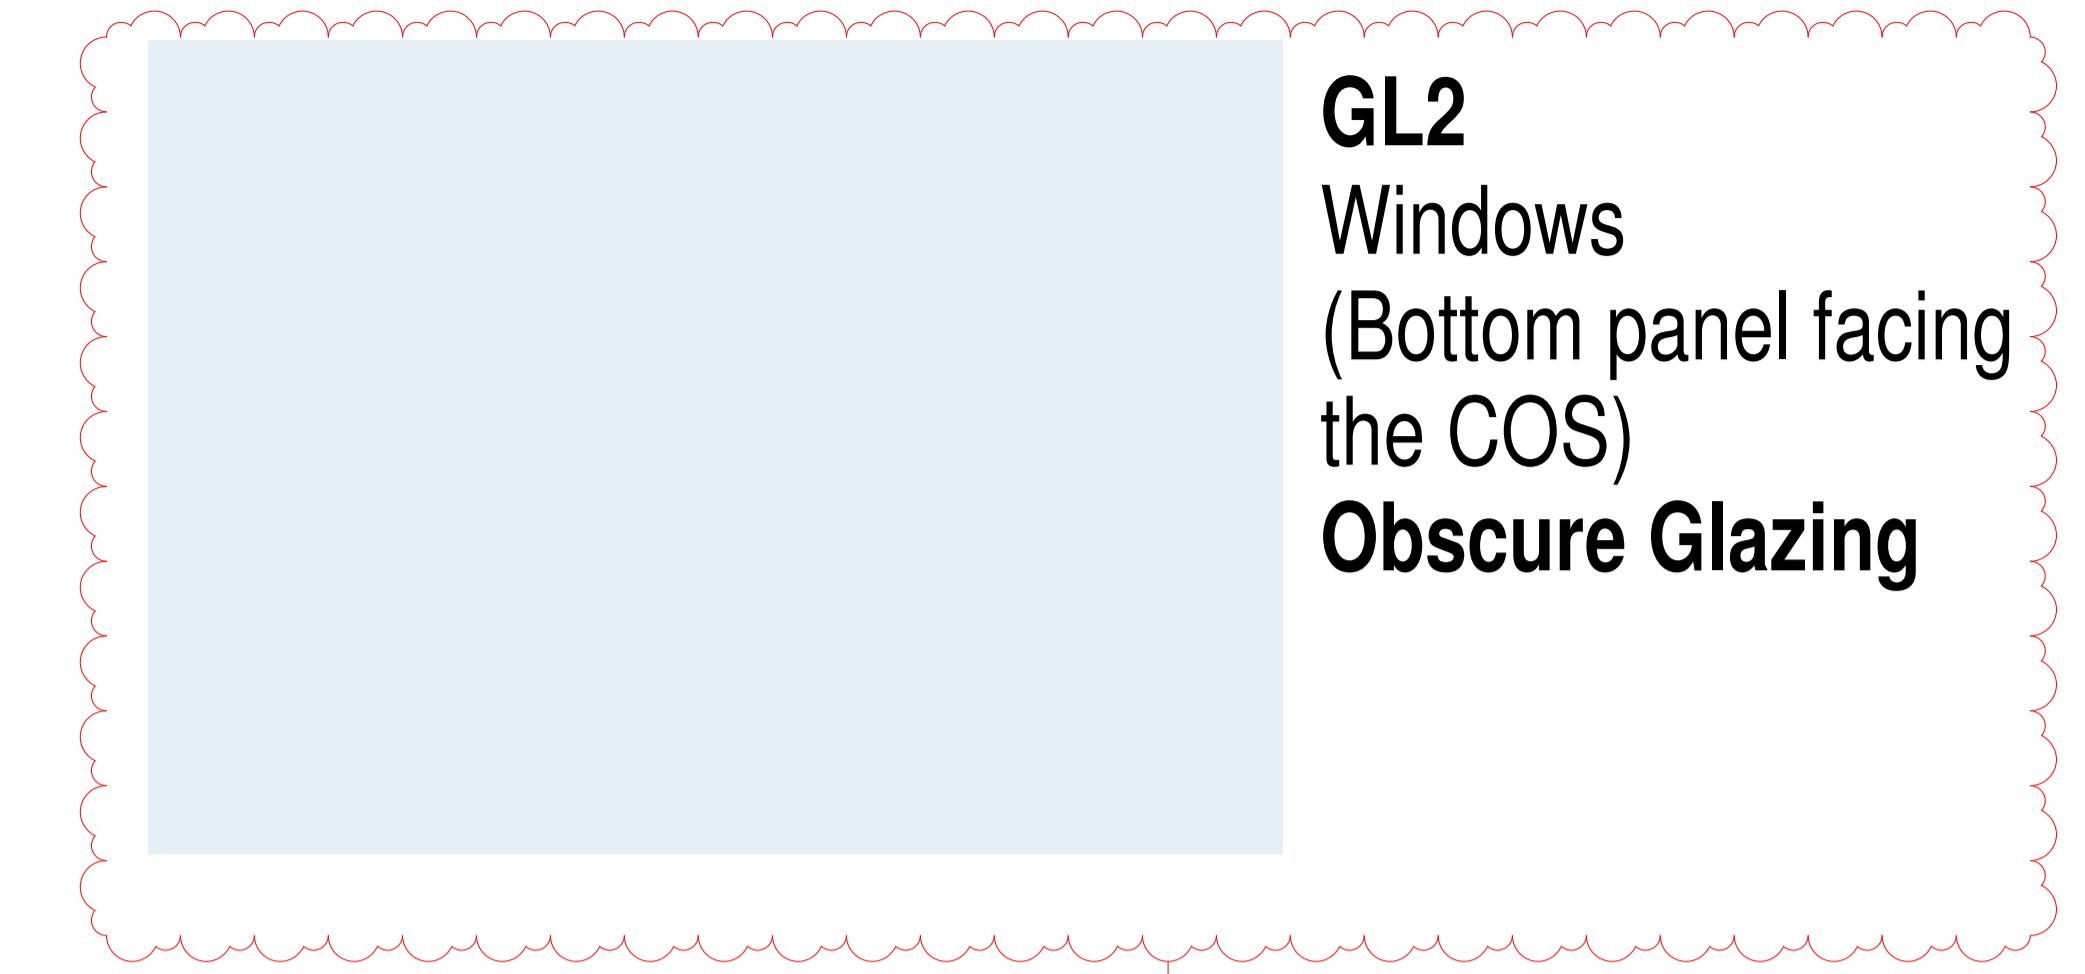

GL2
Windows
(Bottom panel facing
the COS)
Obscure Glazing

B 6




CONC
Concrete
Balconies and
awnings

**Off-white colour
painted concrete**



MFW1 / BAL1 / DP1 / EG1 / MSG
Window Framing System (MFW1)
Balustrade Framing / Louvres
(BAL1)
Wall Capping (MSG)
**Powdercoat colour finish Dark
Grey**

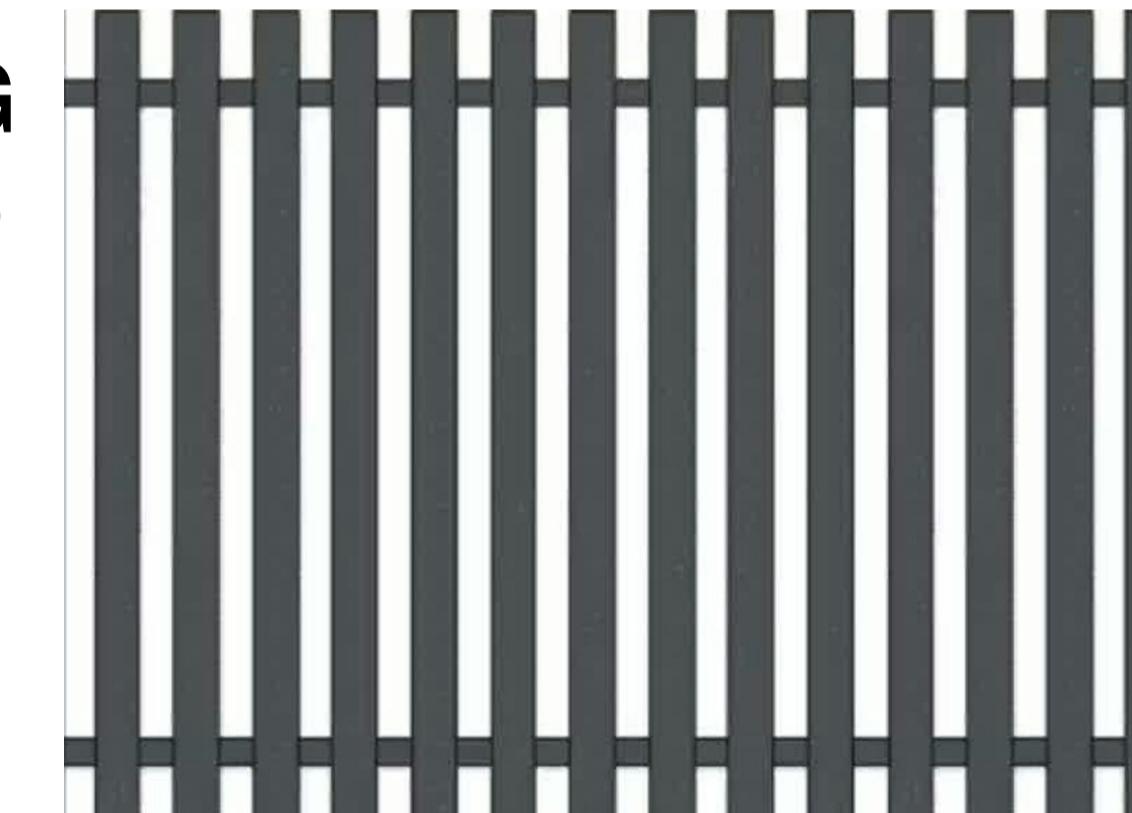

MF1
Metal Vertical
Battened Ground level
gates

**Powdercoat colour
finish Dark Grey**



PTb
Wall Cladding

Paint Finish Dark Grey



MF2
Metal Colorbond
boundary Fence.

**Powdercoat colour
finish Dark Grey**

| ISSUE | DATE | AMENDMENT |
|-------|------------|-----------|
| A | 2024-08-30 | DA ISSUE |
| B | 2025-02-24 | DA MODS. |

24/2/2025 17:45:05

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PROJECT
PANANIA - LAHC 2021/505
ADDRESS
171 Weston St & 2-6 Hinemoa St, Panania, NSW, 2213
LOT 42, 43, 44, 45 / DP35211

CLIENT
NSW LAHC
LOCKED BAG 5022
PHONE 1800 738 718

PROJECT No.
21042
CLIENT
LAHC

MORSON GROUP
NSW GOVERNMENT

NOMINATED ARCHITECT - P F
MORSON REGISTRATION NUMBER 8100
ACN 159 480 056, ABN A159 480 056
PHONE 02 9380 4946
PO Box 170, Potts Point, NSW 1335

SHEET
SIZE: A1
NAME:
SCALE:
1:1

SCHEDULE OF EXTERNAL FINISHES

DRAWING No.
DA27
ISSUE No.
B

